BROADVIEW + DANFORTH



AERIAL VIEW OF PROJECT SITE LOOKING WEST

CLIENT

PROJECT ADDRESS

CP REIT Ontario Properties Limited 700-22 ST CLAIR AVE E, TORONTO, ON M4T 2S5

682-742 BROADVIEW AVE, TORONTO, ON M4K 2P1

CONSULTANTS

ARCHITECT	PLANNER
SUPERKUL INC.	URBAN STRATEGIES IN
101-35 GOLDEN AVENUE	197 SPADINA AVE
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(T) 416.596.0700	(T) 416.340.9004
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TRANSPORTATION ENGINEER WIND CONSULTANT BA CONSULTING GROUP LTD. SLR CONSULTING

95 ST CLAIR AVE W #1000

TORONTO, ON M4V 1N6

GUELPH, ON N1G 5L3

TORONTO, ON M3C 3N7 (T) 416.961.7110 (T) 226.706.8080

LANDSCAPE ARCHITECT TORONTO, ON M6R 1V3

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(T) 416.239.9818

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ECOLOGIST CONSULTANT SLR CONSULTING 100 STONE ROAD WEST, 201

CIVIL ENGINEER COUNTERPOINT ENGINEERING 8395 JANE STREET, SUITE 100 VAUGHAN, ON L4K 5Y2 (T) 905.326.1404

SUSTAINABILITY CONSULTANT

20 FLORAL PARKWAY CONCORD, ON L4K 4R1

(T) 416.645.1186

EQ BUILDING PERFORMANCE INC.


ENERGY ANALYSIS

(T) 416.645.1186

20 FLORAL PARKWAY CONCORD, ON L4K 4R1

EQ BUILDING PERFORMANCE INC.

ISSUED FOR ZBA - 250926

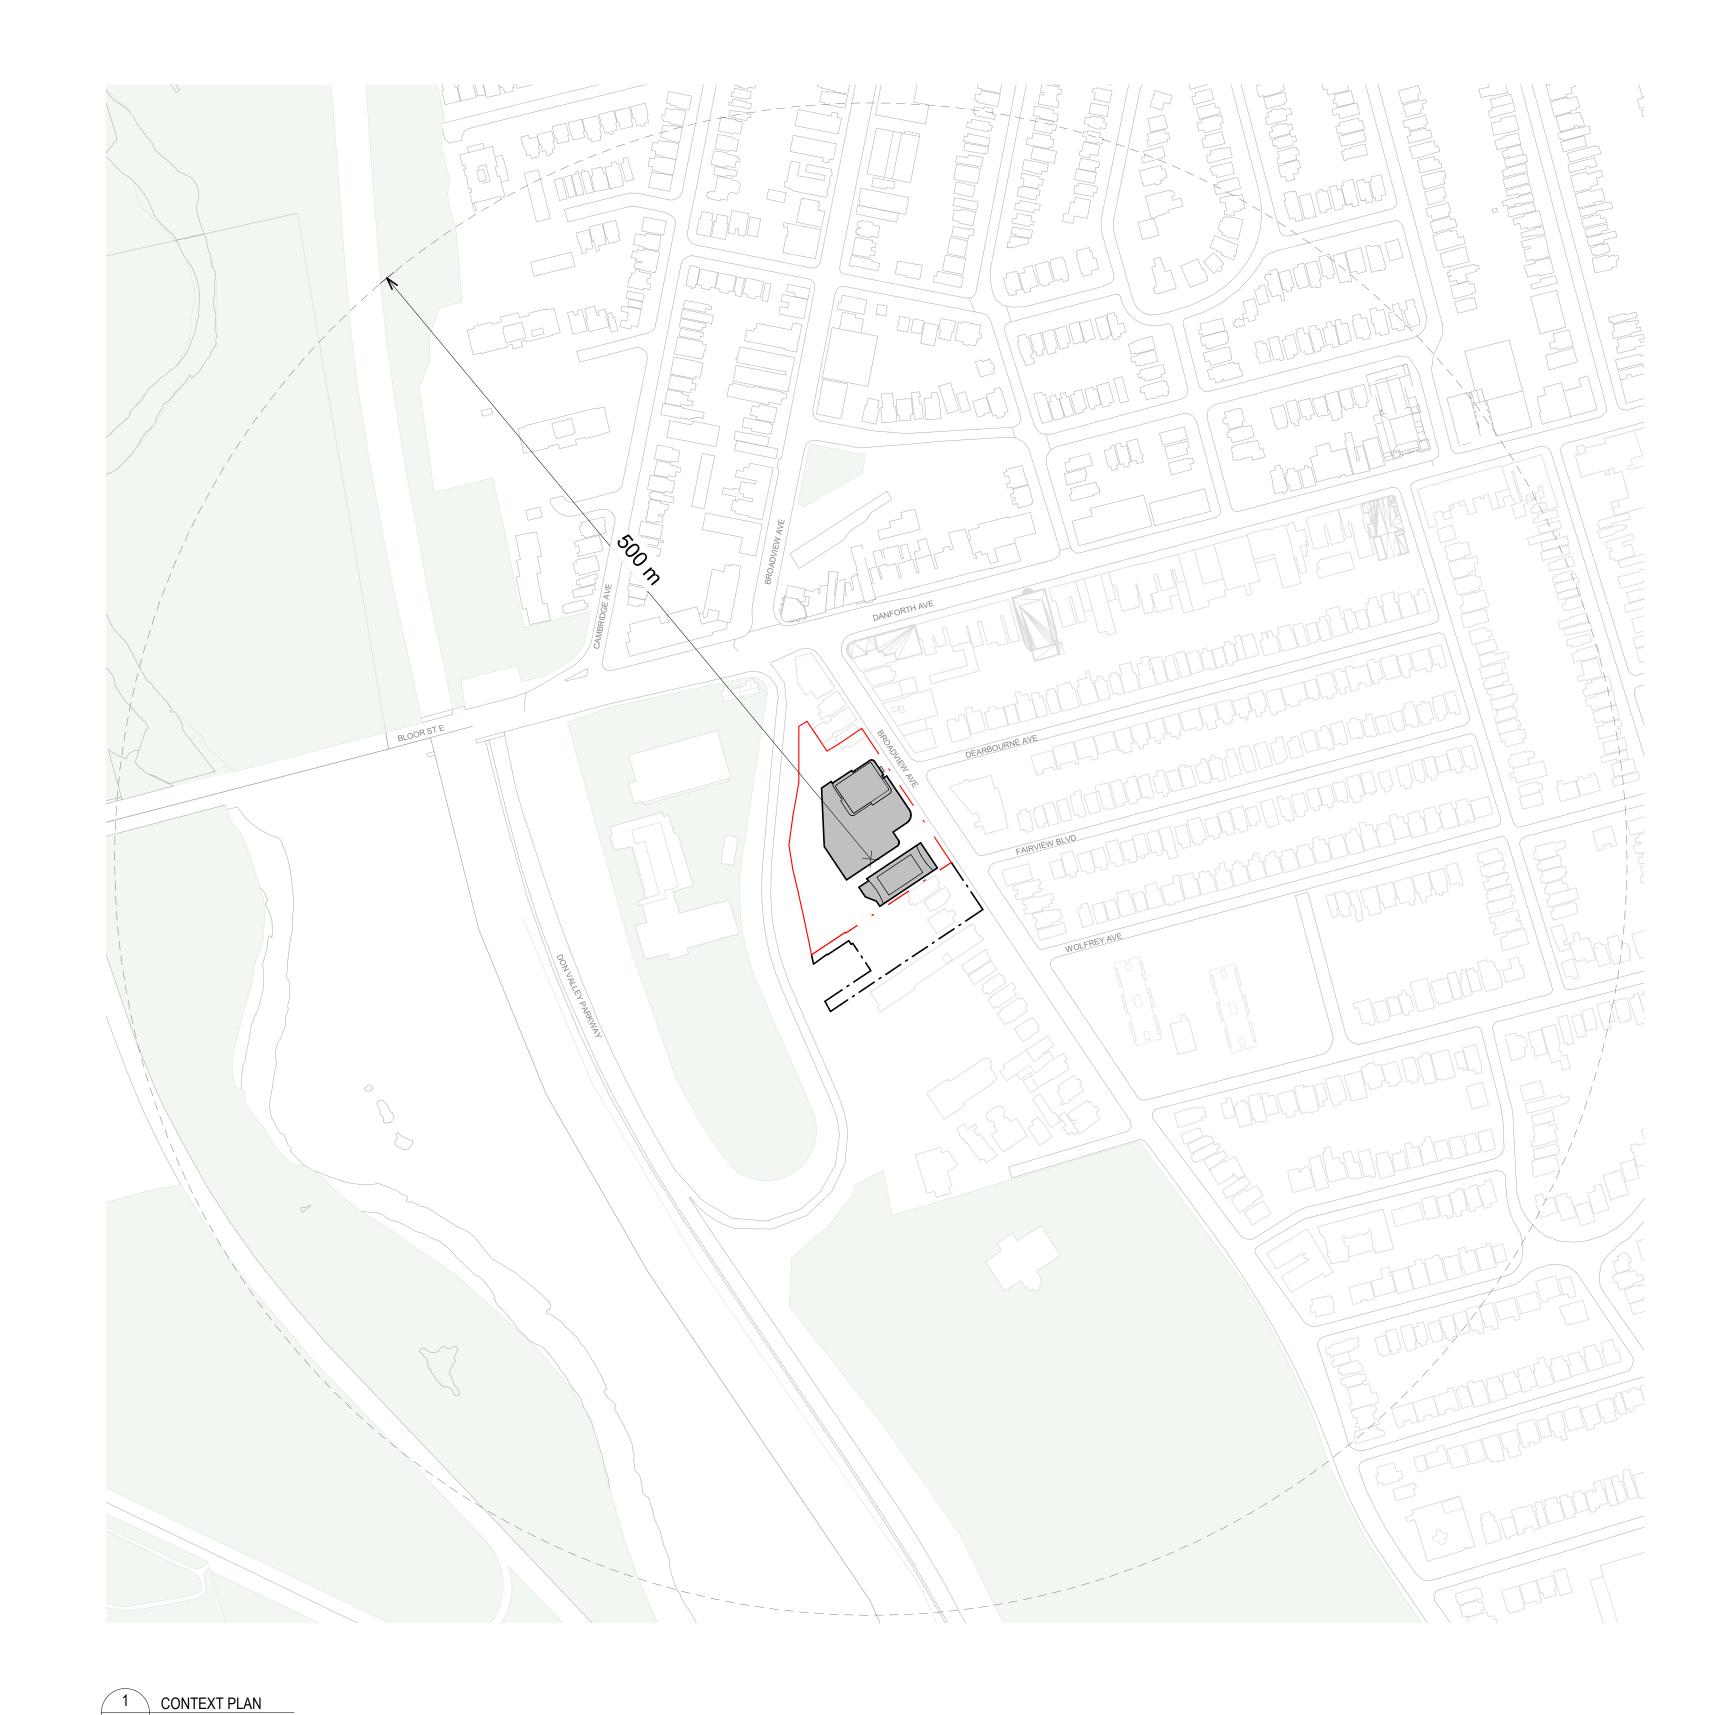

SHEET LIST


DRAWING NUMBER	DRAWING TITLE
000 General	
A 000	Cover Sheet & Drawing List
A 000a	Phasing Diagrams
A 001a	Site Plan - Phase 1
A 001b	Site Plan
A 002	Project Statistics Summary
A 003	Project Statistics - Building A
A 004	Project Statistics - Building B
A 005	ZBL - 569-2013 Area Plans
A 006	Perspective Views
100 Plan	
A 100	Floor Plan - P1
A 101a	Floor Plan - Ground Phase 1
A 101b	Floor Plan - Ground
A 102	Floor Plan - Ground Mezzanine
A 103	Floor Plan - Level 2
A 104	Floor Plan - Level 3-4
A 105	Floor Plan - Level 5-7
A 106	Floor Plan - Level 8-9

DRAWING NUMBER	DRAWING TITLE	
A 107	Floor Plan - Level 10-39	
A 108	Floor Plan - Level 40 / MPH (A)	
A 109	Floor Plan - Level 41	
A 110	Floor Plan - Level 42	
A 111	Floor Plan - MPH (B)	
A 112	Roof Plan	
200 Elevation		
A 200	Building Elevations	
A 201	Building Elevations	
A 202	Building Elevations	
A 203	Building Elevations	
A 204	Building Elevations	
A 205	Building Elevations	
300 Sections		
A 300	Building Section	
A 301	Building Section	

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Prior to commencement of the Work the Contractor shall verify all drawing dimensions, datums, and levels with the Contract Documents and with the conditions on site; ascertain any discrepancies between the site and the Contract Documents, and bring these items to the attention of the Architect for

20250926 20210726 20210610 ZBA Submission 2 ZAA Submission 1 Pre-App Consult. Meeting

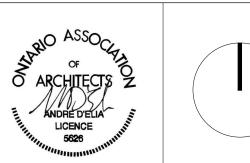



Broadview + Danforth

682-742 Broadview Ave, Toronto, Ontario

Cover Sheet & Drawing


Project No. 2017 Scale As indicated

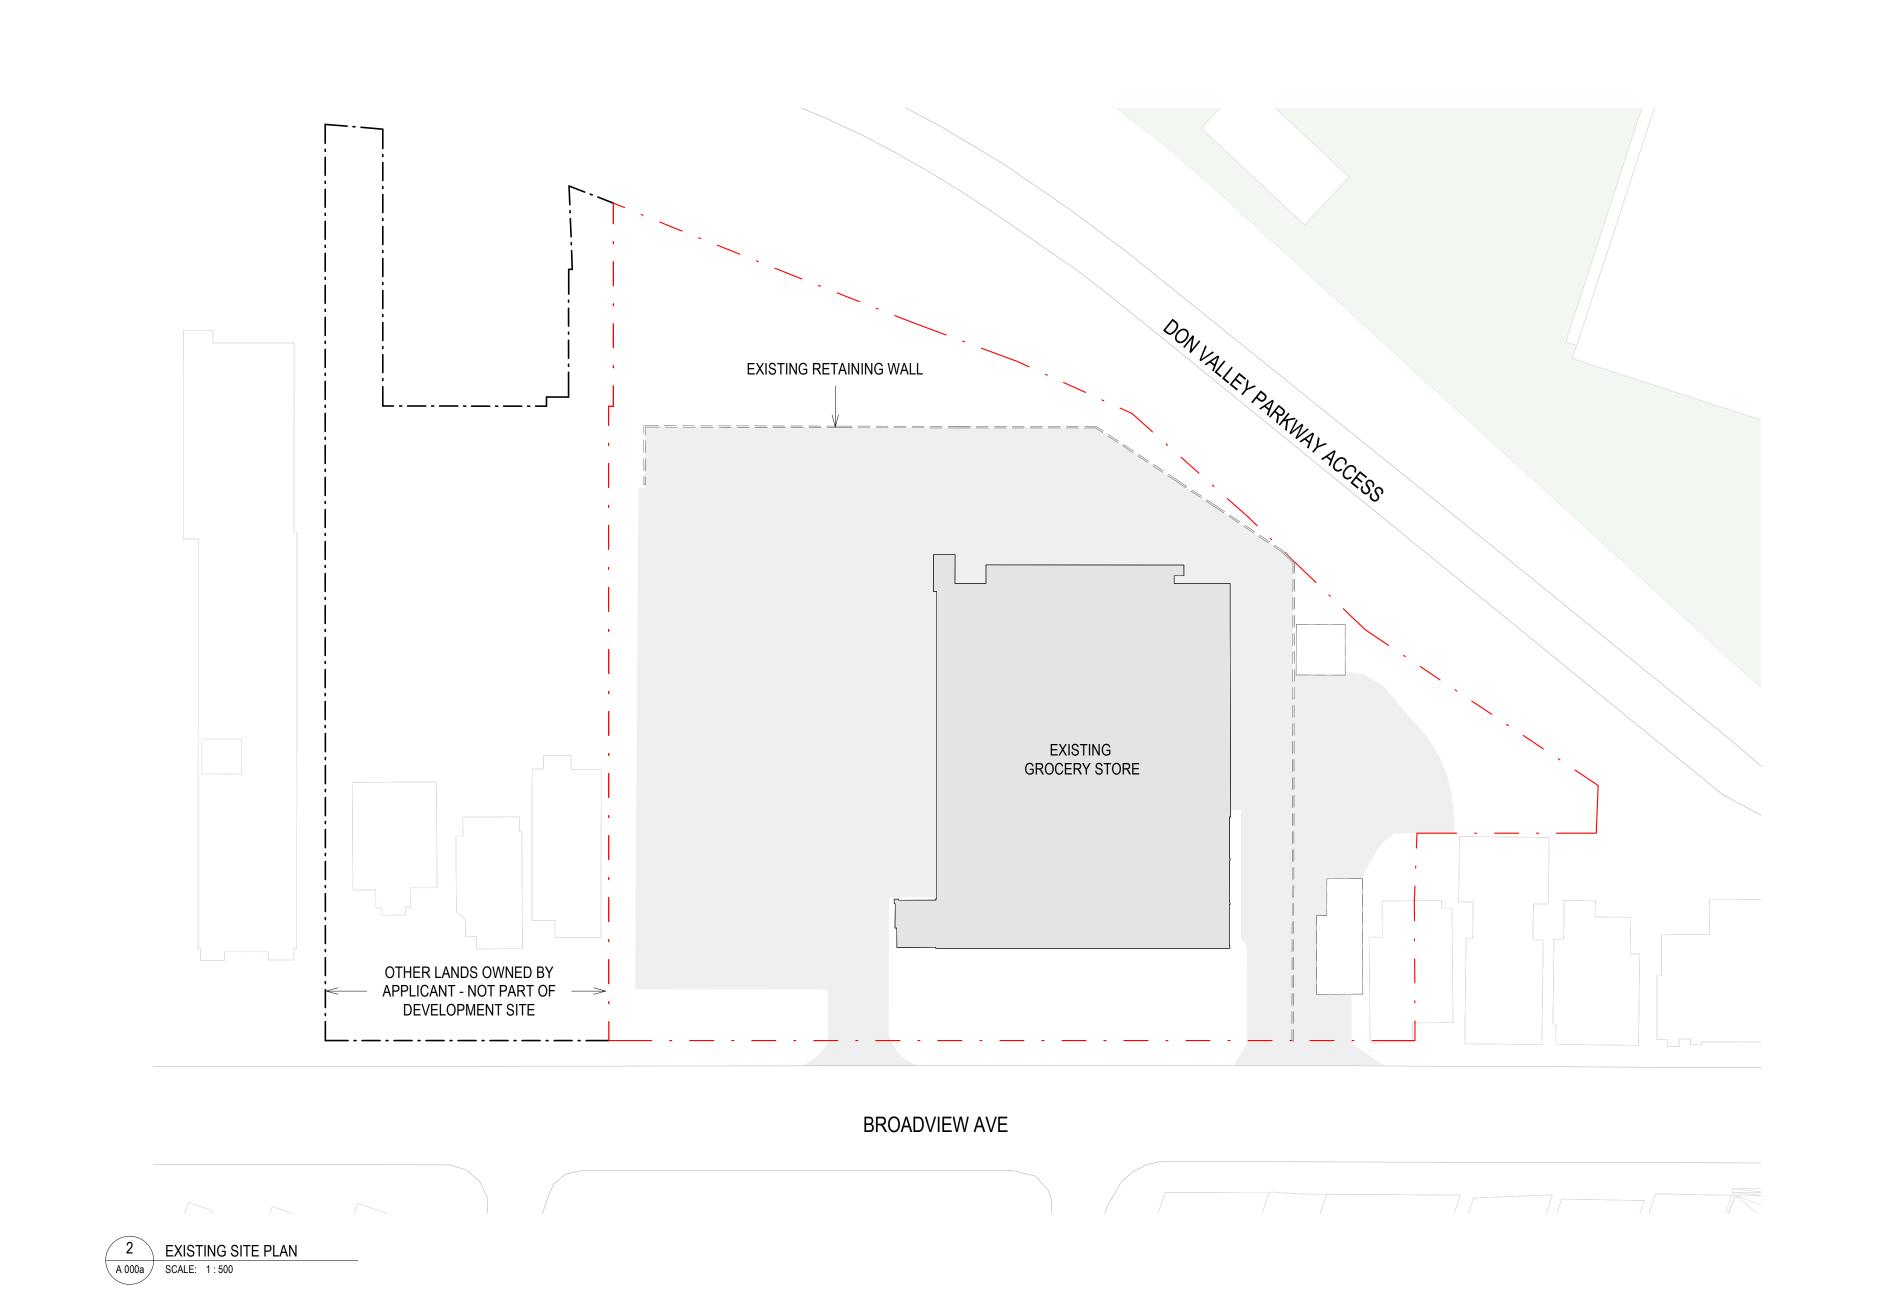

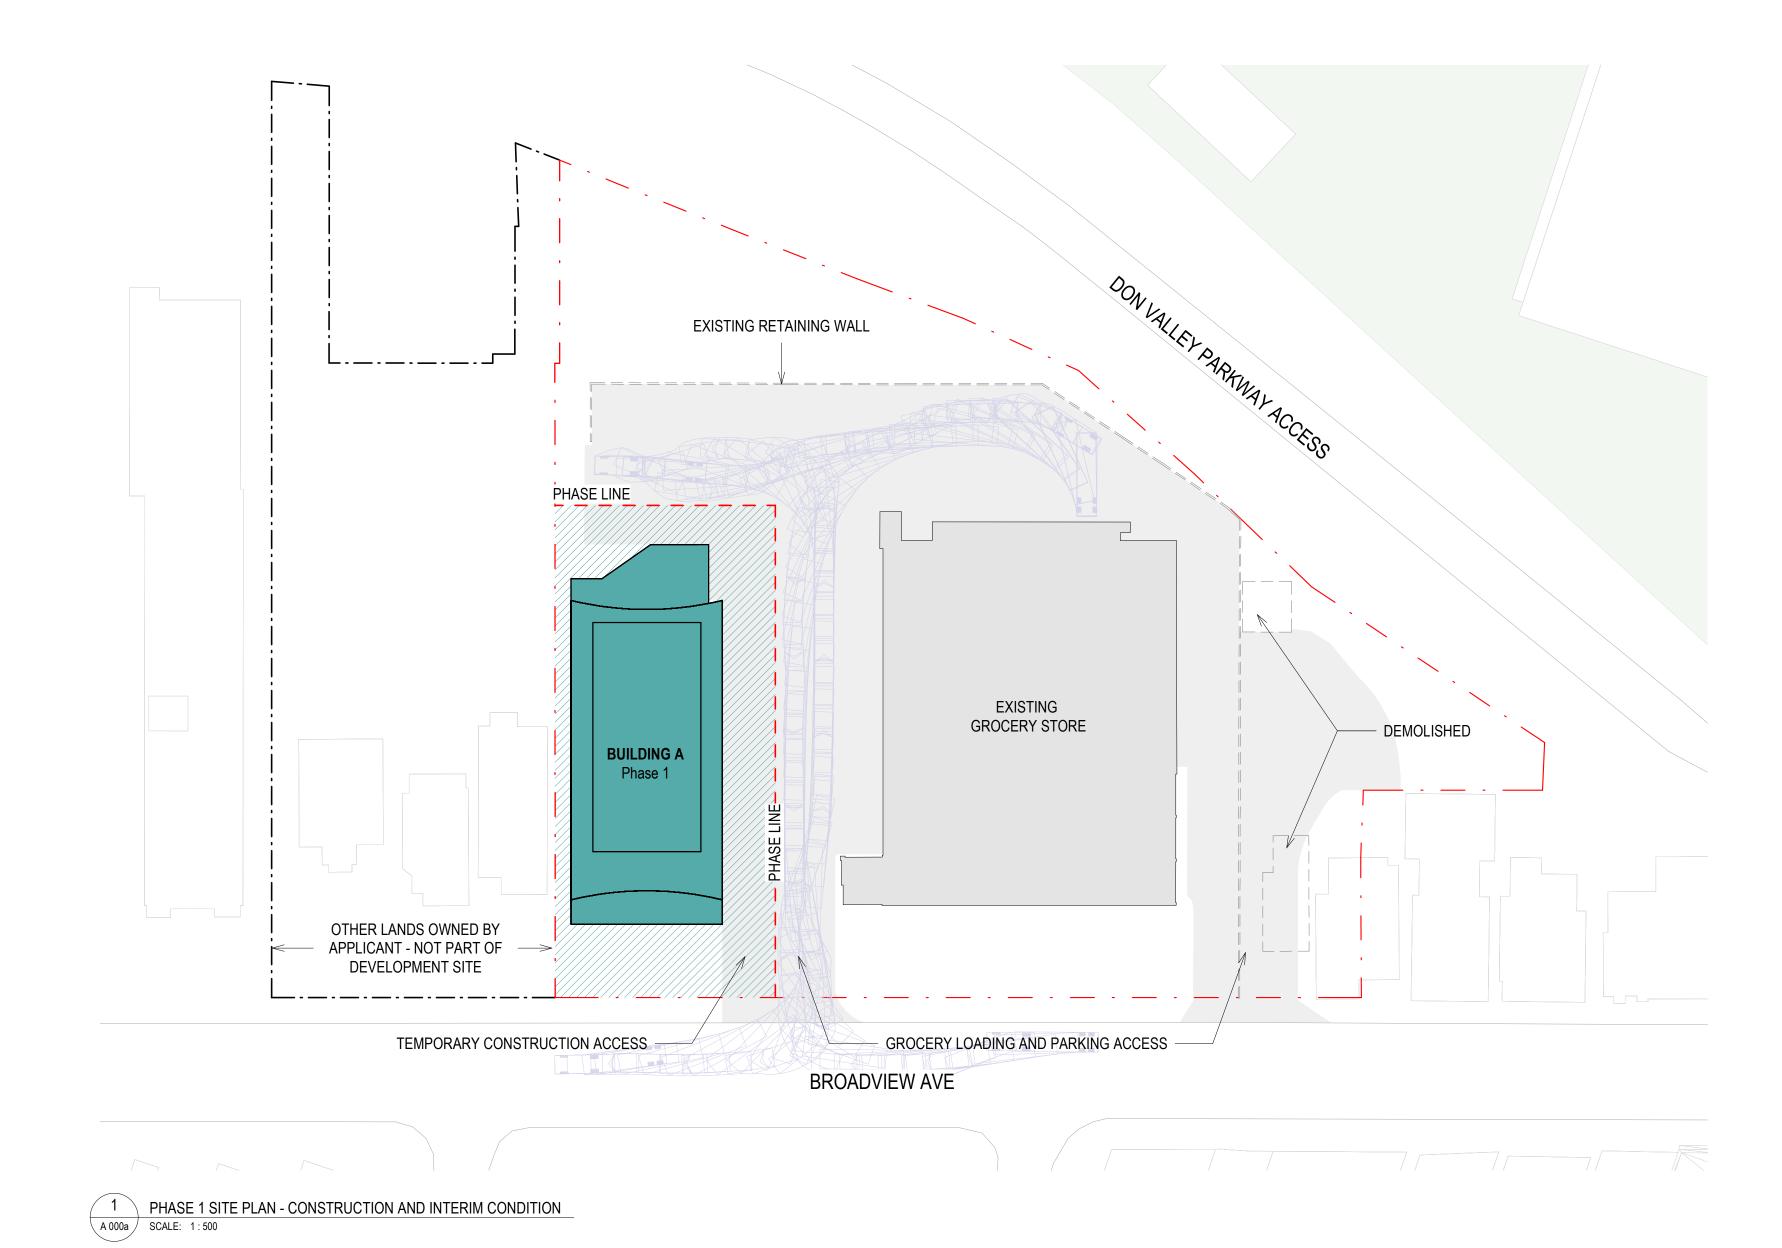

EXISTING RETAINING WALL L.—.—.—. PHASE LINE BUILDING A Phase 1 BUILDING B Phase 2 OTHER LANDS OWNED BY APPLICANT - NOT PART OF DEVELOPMENT SITE LOADING ACCESS -- PARKING ACCESS — LOADING ACCESS **BROADVIEW AVE** 4 PHASE 1 + 2 SITE PLAN - CONSTRUCTION

SCALE: 1:500

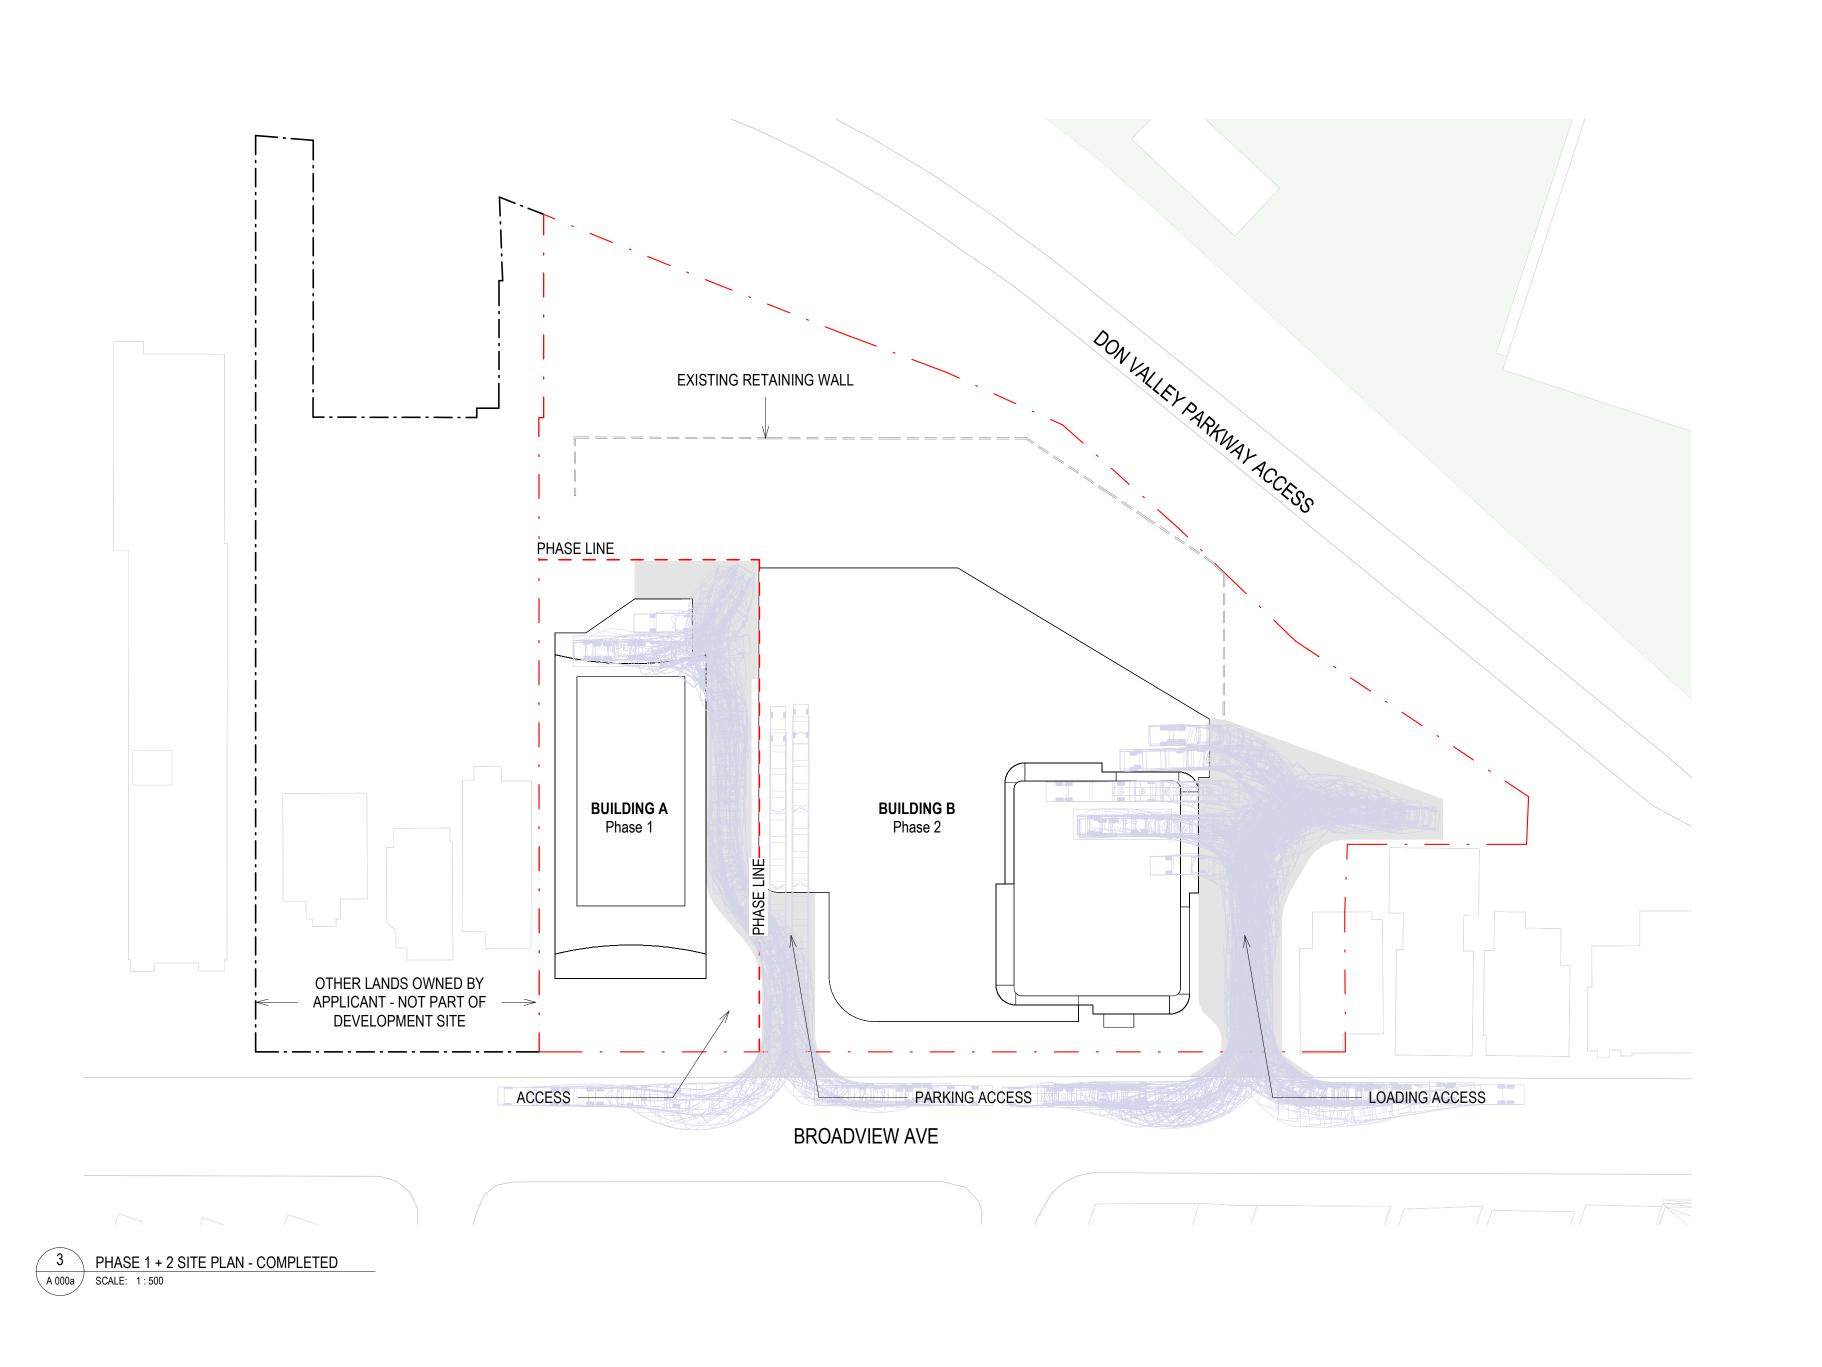

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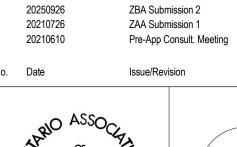
101 - 35 Golden Avenue Toronto, ON M6R 2J5


t> 416.596.0700 f> 416.533.6986 www.superkul.ca **Choice**Properties

PHASING LEGEND

Manuevering

20250926 20210726 20210610



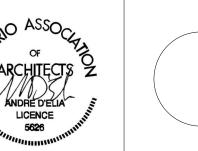



Broadview + Danforth

682-742 Broadview Ave, Toronto, Ontario

Phasing Diagrams

Scale As indicated Project No. 2017

A 000a

superkul inc. (the Architect) and cannot be used for any purpose without the **NOTES AND STATISTICS** written consent of the Architect. This drawing is not to be used for construction until issued for that purpose by the Architect. Prior to commencement of the Work the Contractor shall verify all drawing dimensions, datums, and levels with the Contract Documents and with the conditions on site; ascertain any discrepancies between the site and the Contract Documents, and bring these items to the attention of the Architect for SITE PLAN NOTES 1. THE BUILDING IS TO BE SPRINKLERED. 1. TYPE G LOADING SPACE AND ADJACENT STAGING PAD HAVE VERTICAL CLEARANCE OF MIN 6.1 METERS, OVERHEAD DOOR TO LOADING SPACE WILL HAVE MIN 4.4 METER HEIGHT. 2.1M DEEP STAGING AREA DIRECTLY IN FRONT OF THE LOADING AREA TO HAVE MIN. VERTICAL CLEARANCE OF 6.1M. 54 SQ M STAGING AREA 2. RESIDENTIAL VISITOR PARKING SPACES WILL BE INDIVIDUALLY SIGNED AT THE FRONT OF EACH SPACE FOR THE USE OF RESIDENTIAL VISITORS. BUILDING MANAGEMENT SHALL PROVIDE ENFORCEMENT OF THIS ARRANGEMENT. FOR THE DEVELOPMENT. **GREEN ROOF STATISTICS BUILDING A** GREEN ROOF STATISTICS BUILDING B Gross Floor Area, as defined in Green Roof Bylaw 2. TYPE G LOADING SPACE WILL BE SHARED BETWEEN RESIDENTIAL AND NON-RESIDENTIAL USES. NON-RESIDENTIAL COMPONENT WILL ONLY SCHEDULE USE OF THE TYPE G LOADING SPACE ON DIFFERENT DAYS 3. SIDEWALKS AND BOULEVARDS WITHIN THE RIGHT OF WAY TO HAVE A MINIMUM 1% AND MAXIMUM 4% SLOPE TOWARDS THE ROADWAY. FROM THE COLLECTION DAYS OF THE RESIDENTIAL COMPONENT TO ENSURE THAT THE TYPE G LOADING SPACE WILL BE VACANT FOR CITY WASTE COLLECTION. 4. REFER TO SITE SERVICING DOCUMENTS FOR SEWER AND WATER SERVICE INFORMATION. The total area of each floor level of a building, FLOOR PLATE AREA - The total area of a floor of a building, 3. NON-RESIDENTIAL WASTE WILL BE LABELLED AND STORED SEPARATELY FROM THE BINS FOR RESIDENTIAL WASTE. 5. ANY RETAINING WALLS ARE TO BE PROFESSIONALLY ENGINEERED. above and below average grade, measured from the exterior of the main wall of each floor level, measured from the exterior of the 4. TYPE G LOADING SPACE WILL BE LEVEL (+/- 2%) AND CONSTRUCTED WITH MIN 200mm THICK SACRIFICIAL CONCERETE SLAB 6. ALL EXISTING ACCESSES, CURB CUTS, TRAFFIC CONTROL SIGNS, ETC. ALONG THE DEVELOPMENT SITE FRONTAGES THAT ARE NO main wall of the floor level, including voids at the level of the floor 30,079.6 m² 5. A WARNING SYSTEM WILL BE PROVIDED, ALERTING DRIVERS WHEN EXITING THE UNDERGROUND PARKING GARAGE THAT LARGE TRUCKS ARE MANOEUVRING WITHIN THE PUBLIC LANE; Gross Floor Area, as defined in Green Roof Bylaw (m²) including voids at the level of each floor, such as an such as an atrium, 6. ALL ACCESS DRIVEWAYS TO BE USED BY THE GARBAGE COLLECTION VEHICLE WILL HAVE: REQUIRED ARE TO BE REMOVED. THE BOULEVARD WITHIN THE PUBLIC RIGHT OF WAY, IN ACCORDANCE WITH CITY STANDARDS AND TO 957.5 m² Total Roof Area (m²) mezzanine, stairwell, escalator, elevator, ventilation duct or utility Toronto, ON M6R 2J5 atrium, mezzanine, stairwell, escalator, elevator, a) MAXIMUM GRADIENT OF 8%; ventilation duct or utility shaft, but excluding areas SATISFACTION OF THE EXECUTIVE DIRECTOR OF TECHNICAL SERVICES ARE TO BE REINSTATED.
7. PROPOSED ACCESS TO THE RIGHT-OF-WAY/LANEWAY FOR THIS PROJECT TO BE DESIGNED IN ACCORDANCE WITH CITY STANDARD NO. Area of Residential Private Terraces (m²) b) MINIMUM VERTICAL CLEARANCE OF 4.4 METRES THROUGHOUT; used for the purpose of parking or loading c) MINIMUM WIDTH OF 4.5 METRES THROUGHOUT; AND, t> 416.596.0700 GROSS FLOOR AREA - The total area of each floor level of a Rooftop Outdoor Amenity Space, if in a Residential Building (m²) d) 6 METRES WIDE AT POINT OF INGRESS AND EGRESS. T310-050-1 FOR COMBINED CURB AND SIDEWALK VEHICULAR ENTRANCES. f> 416.533.6986 building, above and below . 'NO PARKING' SIGNS TO BE PROVIDED AND MAINTAINED ADJACENT TO THE LOADING SPACE. 8. NO SPEED BUMPS SHALL BE INSTALLED ON ANY DESIGNATED FIRE ROUTE. Area of Renewable Energy Devices (m2) average grade, measured from the exterior of the main wall of www.superkul.ca 8. CONSTRUCT ANY TYPE G LOADING SPACE AND ALL DRIVEWAYS AND PASSAGEWAYS PROVIDING ACCESS THERETO, TO THE REQUIREMENTS OF THE ONTARIO BUILDING CODE, INCLUDING ALLOWANCE FOR CITY 9. MAX. POROSITY OF ALL GROUND LEVEL VENTILATION GRATES MUST BE 20mm X 20mm PER TORONTO GREEN STANDARDS. each floor level, including voids at Tower(s) Roof Area with floor plate less than 750m² OF TORONTO BULK LIFT AND REAR BIN LOADING WITH IMPACT FACTORS WHERE THEY ARE TO BE BUILT AS SUPPORTED STRUCTURES. 10. ALL EXTERIOR LIGHT FIXTURES TO BE 'DARK SKY' COMPLIANT. the level of each floor, such as an atrium, mezzanine, stairwell, 9. THE RESIDENTIAL SOLID WASTE ROOM WILL ACCOMMODATE GARBAGE, RECYCLING AND ORGANICS FOR THE RESIDENTIAL COMPONENT OF THE BUILDING VIA USE OF A BISORTER IN THE DEVELOPMENT. Total Available Roof Space (m²) 10. BULK WASTE HAS 10m2 DESIGNATED FLOOR AREA FOR THE DEVELOPMENT. UTILITY/SERVICES NOTES Green Roof Coverage Required Provided duct or utility shaft, but excluding areas used for the purpose of 11. "COLLECTION OF WASTE MATERIALS FOR THIS DEVELOPMENT WILL TAKE PLACE IN AN ENCLOSED LOADING BAY. AN ON-SITE STAFF PERSON IS RESPONSIBLE FOR MOVING THE parking or loading Coverage of Available Roof Space (m²) 1. THE METHOD OF INSTALLATION FOR THE PROPOSED SERVICE CONNECTIONS WILL BE AT THE DISCRETION OF TORONTO WATER. 474.8 m² 478.6 m² BINS FROM THE GARBAGE STORAGE SPACE TO THE COLLECTION POINT AND PROVIDE VEHICULAR DIRECTIVES TO THE COLLECTION VEHICLE OPERATOR AS REQUIRED." 12. THIS BUILDING IS DESIGNED WITH A TYPE G LOADING SPACE. A FLASHING WARNING LIGHT SYSTEM AND / OR APPROPRIATE SIGNAGE ADJACENT TO THE SPACE, AT NO COST TO THE CITY, WILL BE IN PLACE AND 2. EXISTING CONNECTIONS NO LONGER IN USE SHALL BE DISCONNECTED BY TORONTO WATER AT THE OWNER'S COST. Coverage of Available Roof Space (%) 60% ACTIVATED DURING COLLECTION AND REMAIN ACTIVE UNTIL THE VEHICLE EXITS THE SITE. REFER TO TRAFFIC CONSULTANT REPORT FOR SWEPT PATH. 3. THE LOCATION OF THE WATER METER SHALL BE TO TORONTO WATER'S SATISFACTION." 13. SOLID WASTE MANAGEMENT TO BE NOTIFIED UPON COMPLETION OF THE DEVELOPMENT AND SHOULD PUBLIC WASTE COLLECTION BE USED, ALL NECESSARY APPLICATION AND WAIVER 4. THE OWNER IS REQUIRED TO INSTALL AND MAINTAIN A PREMISE ISOLATION DEVICE FOR ALL APPLICABLE WATER SERVICES IN FORMS TO BE COMPLETED PRIOR TO COMMENCEMENT OF CITY REFUSE COLLECTION. WITH THE TORONTO MUNICIPAL CODE, CHAPTER 851 WATER SUPPLY, THE BUILDING CODE AND CSA B64 SERIES STANDARDS. 14. NON-RESIDENTIAL GARBAGE WILL BE COLLECTED BY LISCENSED PRIVATE WASTE MANAGEMENT COMPANY. 5. THE BUILDING'S STORM AND SANITARY SYSTEM MUST BE DESIGNED TO BE ABLE TO OPERATE UNDER MUNICIPAL SURCHARGE 15. REFUSE GENERATED BY THE NON-RESIDENTIAL USE MUST BE STORED ON SITE, IN RODENT PROOF CONTAINERS IN ACCORDANCE WITH CHAPTER 841 OF THE MUNICIPAL CODE, "WASTE COLLECTION, 6. BE ADVISED THAT SHOULD ANY PARTY, INCLUDING THE APPLICANT OR ANY SUBSEQUENT OWNER, APPLY FOR MORE THAN ONE 16. TRAINED ON-SITE STAFF MEMBER WILL BE AVAILABLE TO MANOEOUVRE BINS FOR THE COLLECTION DRIVER AND ALSO ACT AS A FLAGMAN WHEN THE TRUCK IS REVERSING. IN THE EVENT THE ON-SITE STAFF IS CONDOMINIUM CORPORATION ENCOMPASSING ANY OR ALL OF THIS DEVELOPMENT OR MAKE AN APPLICATION THAT RESULTS IN A LAND DIVISION, STAFF MAY REQUIRE LEGAL ASSURANCES, INCLUDING BUT NOT LIMITED TO EASEMENTS, WITH RESPECT TO THE APPROVED UNAVAILABLE AT THE TIME THE CITY COLLEGION VEHICLE ARRIVES AT THE SITE, THE COLLECTION VEHICLE WILL LEAVE THE SITE AND NOT RETURN UNTIL THE NEXT SCHEDULED COLLECTION DATE. FOR SPECIFIC TRUCK DIMENSIONS AND TURNING RADII, REFER TO TRAFFIC CONSULTANT'S REPORT. SERVICES. SUCH ASSURANCES WILL BE DETERMINED AT THE TIME OF APPLICATION FOR CONDOMINIUM APPROVAL. PEDESTRIAN ENTRY / EXIT VEHICULAR ENTRY / EXIT CONNECTION FIRE HYDRANT MANHOLE COVER CATCH BASIN EL ELECTRICAL STAND ---- EXTENT OF BELOW GRADE ---- BUILDING ELEMENT ABOVE OPEN TO BELOW EXTENT OF GROUND FLOOR 600X1800mm BICYCLE PARKING SPACE GEODETIC ELEVATION 9524.03 m2 HT: 12.30 m ELEVATION FROM ESTABLISHED GRADE 102515.79 ft2 / 78.20 EXISTING GRADE ELEVATION BARRIER FREE TURNING RADIUS EXISTING RETAINING WALL PROPERTY LINE TO REMAIN PROPERTY LINE - NOT PART OF DEVELOPMENT VEGETATION DRIP LINE 10M SETBACK FROM VEGETATION DRIP LINE LTSTOS (LONG TERM STABLE TOP OF SLOPE) SETBACK FROM LTSTOS
(LONG TERM STABLE TOP OF SLOPE) FFE FINISHED FLOOR ELEVATION TOP TOP OF PARAPET TOR TOP OF ROOF TOS TOP OF STRUCTURE TGS TORONTO GREEN STANDARDS TPZ TREE PROTECTION ZONE SURVEY INFORMATION TAKEN FROM "TOPOGRAPHIC SURVEY OF PART OF LOT 15 CONCESSION 1, LOTS 1 TO 9 BOTH INCLUSIVE ROOF OVER L1 AND PART OF LOT 17 REGISTERED PLAN 274 E, LOADING CITY OF TORONTO" BY SPEIGHT, VAN NOSTRAND & GIBSON LIMITED. DATED APRIL 23, 2025. - EXISTING GARAGE DEMOLISHED - EXISTING RETAINING WALL TO REMAIN - EXISTING CURB REMOVED **BUILDING A BROADVIEW AVE BROADVIEW AVE BROADVIEW AVE BROADVIEW AVE** 39 STOREYS BROADVIEW **BROADVIEW** Broadview + Danforth 682-742 Broadview Ave, Toronto, Ontario Site Plan - Phase 1 A 001a

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SITE PLAN NOTES OVERHEAD DOOR TO LOADING SPACE WILL HAVE MIN 4.4 METER HEIGHT. 2.1M DEEP STAGING AREA DIRECTLY IN FRONT OF THE LOADING AREA TO HAVE MIN. VERTICAL CLEARANCE OF 6.1M. 54 SQ M STAGING AREA 2. TYPE G LOADING SPACE MAY BE SHARED BETWEEN RESIDENTIAL AND NON-RESIDENTIAL USES. NON-RESIDENTIAL COMPONENT WILL ONLY SCHEDULE USE OF THE TYPE G LOADING SPACE ON DIFFERENT DAYS

1. THE BUILDING IS TO BE SPRINKLERED. 2. RESIDENTIAL VISITOR PARKING SPACES WILL BE INDIVIDUALLY SIGNED AT THE FRONT OF EACH SPACE FOR THE USE OF RESIDENTIAL VISITORS. BUILDING MANAGEMENT SHALL PROVIDE ENFORCEMENT OF THIS ARRANGEMENT. 3. SIDEWALKS AND BOULEVARDS WITHIN THE RIGHT OF WAY TO HAVE A MINIMUM 1% AND MAXIMUM 4% SLOPE TOWARDS THE ROADWAY. 4. REFER TO SITE SERVICING DOCUMENTS FOR SEWER AND WATER SERVICE INFORMATION. 5. ANY RETAINING WALLS ARE TO BE PROFESSIONALLY ENGINEERED. 6. ALL EXISTING ACCESSES, CURB CUTS, TRAFFIC CONTROL SIGNS, ETC. ALONG THE DEVELOPMENT SITE FRONTAGES THAT ARE NO LONGER REQUIRED ARE TO BE REMOVED. THE BOULEVARD WITHIN THE PUBLIC RIGHT OF WAY, IN ACCORDANCE WITH CITY STANDARDS

7. PROPOSED ACCESS TO THE RIGHT-OF-WAY/LANEWAY FOR THIS PROJECT TO BE DESIGNED IN ACCORDANCE WITH CITY STANDARD NO. T310-050-1 FOR COMBINED CURB AND SIDEWALK VEHICULAR ENTRANCES. 8. NO SPEED BUMPS SHALL BE INSTALLED ON ANY DESIGNATED FIRE ROUTE. 9. MAX. POROSITY OF ALL GROUND LEVEL VENTILATION GRATES MUST BE 20mm X 20mm PER TORONTO GREEN STANDARDS. 10. ALL EXTERIOR LIGHT FIXTURES TO BE 'DARK SKY' COMPLIANT. **UTILITY/SERVICES NOTES**

AND TO THE SATISFACTION OF THE EXECUTIVE DIRECTOR OF TECHNICAL SERVICES ARE TO BE REINSTATED.

1. THE METHOD OF INSTALLATION FOR THE PROPOSED SERVICE CONNECTIONS WILL BE AT THE DISCRETION OF TORONTO WATER. 2. EXISTING CONNECTIONS NO LONGER IN USE SHALL BE DISCONNECTED BY TORONTO WATER AT THE OWNER'S COST. 3. THE LOCATION OF THE WATER METER SHALL BE TO TORONTO WATER'S SATISFACTION." 4. THE OWNER IS REQUIRED TO INSTALL AND MAINTAIN A PREMISE ISOLATION DEVICE FOR ALL APPLICABLE WATER SERVICES IN ACCORDANCE WITH THE TORONTO MUNICIPAL CODE, CHAPTER 851 WATER SUPPLY, THE BUILDING CODE AND CSA B64 SERIES 5. THE BUILDING'S STORM AND SANITARY SYSTEM MUST BE DESIGNED TO BE ABLE TO OPERATE UNDER MUNICIPAL SURCHARGE

Contract Documents, and bring these items to the attention of the Architect for

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14. NON-RESIDENTIAL GARBAGE WILL BE COLLECTED BY LISCENSED PRIVATE WASTE MANAGEMENT COMPANY. 6. BE ADVISED THAT SHOULD ANY PARTY, INCLUDING THE APPLICANT OR ANY SUBSEQUENT OWNER, APPLY FOR MORE THAN ONE 15. REFUSE GENERATED BY THE NON-RESIDENTIAL USE MUST BE STORED ON SITE, IN RODENT PROOF CONTAINERS IN ACCORDANCE WITH CHAPTER 841 OF THE MUNICIPAL CODE, "WASTE COLLECTION, CONDOMINIUM CORPORATION ENCOMPASSING ANY OR ALL OF THIS DEVELOPMENT OR MAKE AN APPLICATION THAT RESULTS IN A LAND DIVISION, STAFF MAY REQUIRE LEGAL ASSURANCES, INCLUDING BUT NOT LIMITED TO EASEMENTS, WITH RESPECT TO THE APPROVED 16. TRAINED ON-SITE STAFF MEMBER WILL BE AVAILABLE TO MANOEOUVRE BINS FOR THE COLLECTION DRIVER AND ALSO ACT AS A FLAGMAN WHEN THE TRUCK IS REVERSING. IN THE EVENT THE ON-SITE STAFF IS SERVICES. SUCH ASSURANCES WILL BE DETERMINED AT THE TIME OF APPLICATION FOR CONDOMINIUM APPROVAL. UNAVAILABLE AT THE TIME THE CITY COLLEGION VEHICLE ARRIVES AT THE SITE, THE COLLECTION VEHICLE WILL LEAVE THE SITE AND NOT RETURN UNTIL THE NEXT SCHEDULED COLLECTION DATE. FOR SPECIFIC TRUCK DIMENSIONS AND TURNING RADII, REFER TO TRAFFIC CONSULTANT'S REPORT. **LEGEND** PEDESTRIAN ENTRY / EXIT VEHICULAR ENTRY / EXIT CONNECTION FIRE HYDRANT MANHOLE COVER CATCH BASIN EL ELECTRICAL STAND ---- EXTENT OF BELOW GRADE ---- BUILDING ELEMENT ABOVE OPEN TO BELOW EXTENT OF GROUND FLOOR 600X1800mm BICYCLE PARKING SPACE GEODETIC ELEVATION 9524.03 m2 HT: 12.30 m ELEVATION FROM ESTABLISHED GRADE 102515.79 ft2 / 78.20 EXISTING GRADE ELEVATION BARRIER FREE TURNING RADIUS - EXISTING RETAINING WALL PROPERTY LINE TO REMAIN PROPERTY LINE - NOT PART OF DEVELOPMENT VEGETATION DRIP LINE 10M SETBACK FROM VEGETATION DRIP LINE OPEN SPACE LTSTOS (LONG TERM STABLE TOP OF SLOPE) 1584.00 m2 17049.99 ft2 SETBACK FROM LTSTOS
(LONG TERM STABLE TOP OF SLOPE) FFE FINISHED FLOOR ELEVATION TOP TOP OF PARAPET TOR TOP OF ROOF - EXISTING GROCERY STORE DEMOLISHED TOS TOP OF STRUCTURE TGS TORONTO GREEN STANDARDS TPZ TREE PROTECTION ZONE SURVEY INFORMATION TAKEN FROM "TOPOGRAPHIC SURVEY OF PART OF LOT 15 CONCESSION 1, LOTS 1 TO 9 BOTH INCLUSIVE ROOF OVER L1 AND PART OF LOT 17 REGISTERED PLAN 274 E, LOADING CITY OF TORONTO" BY SPEIGHT, VAN NOSTRAND & GIBSON LIMITED. DATED APRIL 23, 2025. - EXISTING GARAGE DEMOLISHED - EXISTING RETAINING WALL TO REMAIN - EXISTING CURB REMOVED ROOF OVER L1 **GROCERY STORE** WIND TRELLIS **BUILDING A BROADVIEW AVE BROADVIEW AVE BROADVIEW AVE BROADVIEW AVE** 39 STOREYS 42 STOREYS AVE DEMOLISHED GROUND FLOOR NOT PART OF DEVELOPMENT SITE Broadview + Danforth

1. TYPE G LOADING SPACE AND ADJACENT STAGING PAD HAVE VERTICAL CLEARANCE OF MIN 6.1 METERS.

6. ALL ACCESS DRIVEWAYS TO BE USED BY THE GARBAGE COLLECTION VEHICLE WILL HAVE:

'NO PARKING' SIGNS TO BE PROVIDED AND MAINTAINED ADJACENT TO THE LOADING SPACE.

b) MINIMUM VERTICAL CLEARANCE OF 4.4 METRES THROUGHOUT;

10. BULK WASTE HAS 10m2 DESIGNATED FLOOR AREA FOR THE DEVELOPMENT.

FORMS TO BE COMPLETED PRIOR TO COMMENCEMENT OF CITY REFUSE COLLECTION.

c) MINIMUM WIDTH OF 4.5 METRES THROUGHOUT; AND,

d) 6 METRES WIDE AT POINT OF INGRESS AND EGRESS.

3. NON-RESIDENTIAL WASTE WILL BE LABELLED AND STORED SEPARATELY FROM THE BINS FOR RESIDENTIAL WASTE.

4. TYPE G LOADING SPACE WILL BE LEVEL (+/- 2%) AND CONSTRUCTED WITH MIN 200mm THICK SACRIFICIAL CONCERETE SLAB

OF TORONTO BULK LIFT AND REAR BIN LOADING WITH IMPACT FACTORS WHERE THEY ARE TO BE BUILT AS SUPPORTED STRUCTURES.

FROM THE COLLECTION DAYS OF THE RESIDENTIAL COMPONENT TO ENSURE THAT THE TYPE G LOADING SPACE WILL BE VACANT FOR CITY WASTE COLLECTION.

5. A WARNING SYSTEM WILL BE PROVIDED, ALERTING DRIVERS WHEN EXITING THE UNDERGROUND PARKING GARAGE THAT LARGE TRUCKS ARE MANOEUVRING WITHIN THE PUBLIC LANE;

11. "COLLECTION OF WASTE MATERIALS FOR THIS DEVELOPMENT WILL TAKE PLACE IN AN ENCLOSED LOADING BAY. AN ON-SITE STAFF PERSON IS RESPONSIBLE FOR MOVING THE

13. SOLID WASTE MANAGEMENT TO BE NOTIFIED UPON COMPLETION OF THE DEVELOPMENT AND SHOULD PUBLIC WASTE COLLECTION BE USED, ALL NECESSARY APPLICATION AND WAIVER

BINS FROM THE GARBAGE STORAGE SPACE TO THE COLLECTION POINT AND PROVIDE VEHICULAR DIRECTIVES TO THE COLLECTION VEHICLE OPERATOR AS REQUIRED."

ACTIVATED DURING COLLECTION AND REMAIN ACTIVE UNTIL THE VEHICLE EXITS THE SITE. REFER TO TRAFFIC CONSULTANT REPORT FOR SWEPT PATH.

: CONSTRUCT ANY TYPE G LOADING SPACE AND ALL DRIVEWAYS AND PASSAGEWAYS PROVIDING ACCESS THERETO, TO THE REQUIREMENTS OF THE ONTARIO BUILDING CODE, INCLUDING ALLOWANCE FOR CITY

12. THIS BUILDING IS DESIGNED WITH A TYPE G LOADING SPACE. A FLASHING WARNING LIGHT SYSTEM AND / OR APPROPRIATE SIGNAGE ADJACENT TO THE SPACE, AT NO COST TO THE CITY, WILL BE IN PLACE AND

9. THE RESIDENTIAL SOLID WASTE ROOM WILL ACCOMMODATE GARBAGE, RECYCLING AND ORGANICS FOR THE RESIDENTIAL COMPONENT OF THE BUILDING VIA USE OF A BISORTER IN THE DEVELOPMENT.

FOR THE DEVELOPMENT.

a) MAXIMUM GRADIENT OF 8%;

FLOOR PLATE AREA - The total area of a floor of a building,

main wall of the floor level, including voids at the level of the floor

GROSS FLOOR AREA - The total area of each floor level of a

average grade, measured from the exterior of the main wall of

the level of each floor, such as an atrium, mezzanine, stairwell,

duct or utility shaft, but excluding areas used for the purpose of

mezzanine, stairwell, escalator, elevator, ventilation duct or utility

measured from the exterior of the

building, above and below

each floor level, including voids at

such as an atrium,

parking or loading

shaft.

Gross Floor Area, as defined in Green Roof Bylaw

above and below average grade, measured from the exterior of the main wall of each floor level,

atrium, mezzanine, stairwell, escalator, elevator,

used for the purpose of parking or loading

including voids at the level of each floor, such as an

ventilation duct or utility shaft, but excluding areas

The total area of each floor level of a building,

3.011.8 m²

2,067.2 m²

1,240.3 m² 1,294.2 m²

60%

GREEN ROOF STATISTICS BUILDING A

Area of Residential Private Terraces (m²)

Area of Renewable Energy Devices (m2)

Total Roof Area (m²)

Green Roof Coverage

Total Available Roof Space (m²)

Coverage of Available Roof Space (m²)

Coverage of Available Roof Space (%)

Gross Floor Area, as defined in Green Roof Bylaw (m²)

Tower(s) Roof Area with floor plate less than 750m²

Rooftop Outdoor Amenity Space, if in a Residential Building (m²)

GREEN ROOF STATISTICS BUILDING B

Area of Residential Private Terraces (m²)

Area of Renewable Energy Devices (m2)

Gross Floor Area, as defined in Green Roof Bylaw (m²)

Tower(s) Roof Area with floor plate less than 750m²

Rooftop Outdoor Amenity Space, if in a Residential Building (m²)

Green Roof

Total Roof Area (m²)

Green Roof Coverage

Total Available Roof Space (m²)

Coverage of Available Roof Space (m²)

Coverage of Available Roof Space (%)

30,079.6 m²

Required Provided

60%

474.8 m² 478.6 m²

957.5 m²

682-742 Broadview Ave, Toronto, Ontario

A 001b

BUILDING A AND B STATISTICS SUMMARY Overall Statistics Summary | Total GCA | GFA | Deductions | Residential | Non-Residential | Indoor | Outdoor | 10% | 30249.06 | 4170.51 | 26078.55 | 0.00 | 1097.62 | 443.41 | | 20592.04 | 4401.73 | 29891.61 | 2288.70 | 944.09 | 944.58 | Total Unit # of Storeys Count
 Count
 Studio
 1 BD
 2 BD
 3 BD
 Total GCA
 Deductions
 Residential
 No

 385
 30
 8%
 212
 55%
 105
 27%
 38
 10%
 30249.06
 4170.51
 26078.55

 472
 42
 9%
 266
 56%
 118
 25%
 46
 10%
 36582.04
 4401.73
 29891.61
 857 72 8% 478 56% 223 26% 84 10% 66831 8572 55970

SITE FSI: 6.12

			Area	Summary					Re	sidential
Level	Count	Total GLA	Total GCA	GFA Deductions	(Residential	GFA Non-Residential	Total GFA	Level	Studio	1 BD
Below Grade								Below Grade		
P1	1	0.00	0.00	0.00	0.00	0.00	0.00	P1	0	(
Above Grade								Above Grade		
Ground	1	0.00	784.34	224.54	559.80	0.00	559.80	Ground	0	(
Mezzanine	1	0.00	676.59	609.47	67.12	0.00	67.12	Mezzanine	0	
2	1	0.00	792.00	243.48	548.52	0.00	548.52	2	0	
3-4	2	0.00	1584.00	112.84	1471.16	0.00	1471.16	3-4	0	1
5-7	3	0.00	2376.00	169.26	2206.74	0.00	2206.74	5-7	0	2
8-9	2	0.00	853.47	732.89	120.58	0.00	120.58	8-9	0	(
10-39	30	0.00	22797.23	1692.60	21104.63	0.00	21104.63	10-39	30	180
40 (MPH)	1	0.00	385.42	385.42	0.00	0.00	0.00	40 (MPH)	0	(
Project Totals	-	0.00	30249.06	4170.51	26078.55	0.00	26078.55	Proposed Unit Mix	30	212
									8%	55%
								Average Unit Size (m²)	29.36	51.2
								(ft²)	316	55

BUILDING	B STATISTIC	S							SITE	E FSI: 6.12
			Area	Summary				Residential Units		
Level	Count	Total GLA	Total GCA	GFA Deductions	Residential	FA Non-Residential	Total GFA	Level Studio 1 BD 2 BD	3 BD	Total Uni
Below Grade								Below Grade		
P1	1	0.00	0.00	0.00	0.00	0.00	0.00	P1 0 0 0	0	
Above Grade						,		Above Grade		
Ground	1	0.00	2882.42	575.55	345.52	1961.35	2306.87	Ground 0 0 0	0	
Mezzanine	1	0.00	843.51	457.74	58.42	327.35	385.77	Mezzanine 0 0 0	0	
2	1	0.00	766.54	700.79	65.75	0.00	65.75	2 0 0 0	0	
3-39	37	0.00	29343.87	1951.38	27392.49	0.00	27392.49	3-39 37 259 111	37	4
40	1	0.00	750.37	52.74	697.63	0.00	697.63	40 1 4 2	3	
41	1	0.00	706.13	52.74	653.39	0.00	653.39	41 1 2 3	3	
42	1	0.00	665.64	52.74	612.90	0.00	612.90	42 3 1 2	3	
B MPH	1	0.00	623.56	558.05	65.51	0.00	65.51	B MPH 0 0 0	0	
Project Totals	-	0.00	36582.04	4401.73	29891.61	2288.70	32180.30	Proposed Unit Mix 42 266 118	46	
,								9% 56% 25%	10%	
								Average Unit Size (m²) 33.79 49.99 67.09	82.31	58
								(ft²) 364 538 722	886	
								15% BF Required 7 40 18	7	
					Total GFA	32,180.30 m ²	346,386 ft ²	BF Provided 0 0 0	0	

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20250926 20210726 20210610 ZBA Submission 2 ZAA Submission 1


Pre-App Consult. Meeting

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Project Statistics Summary

Project No. 2017



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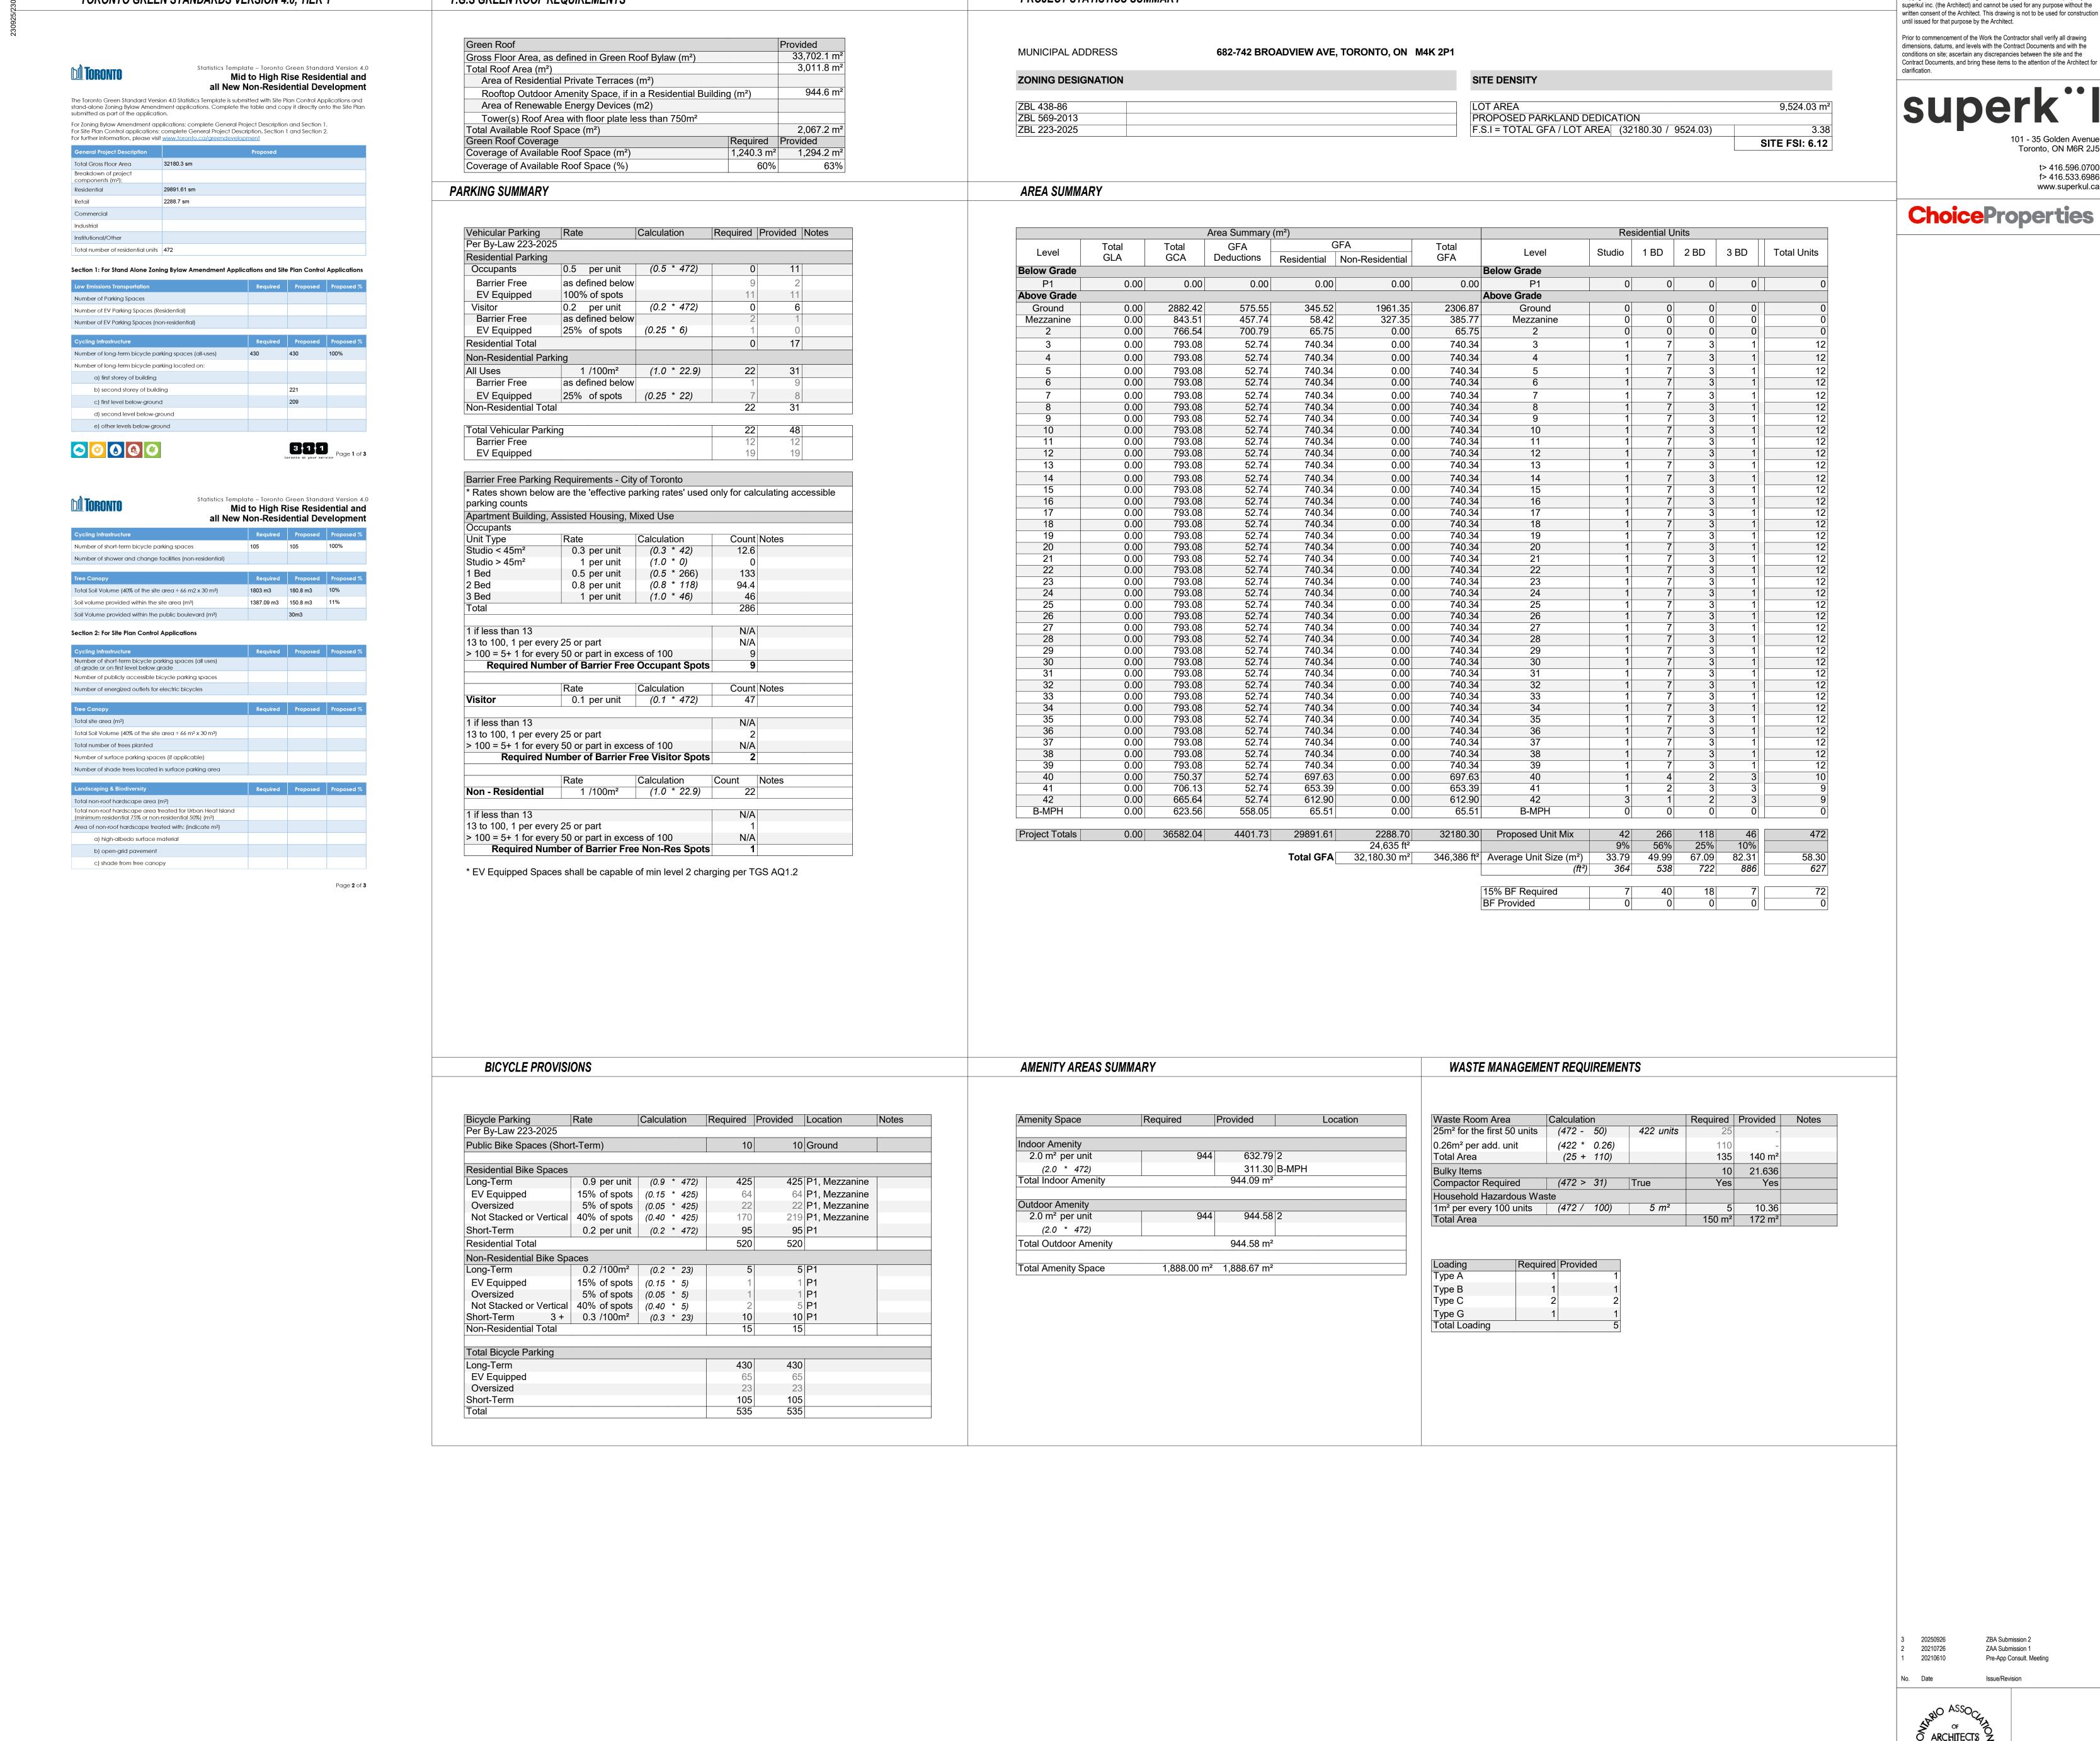

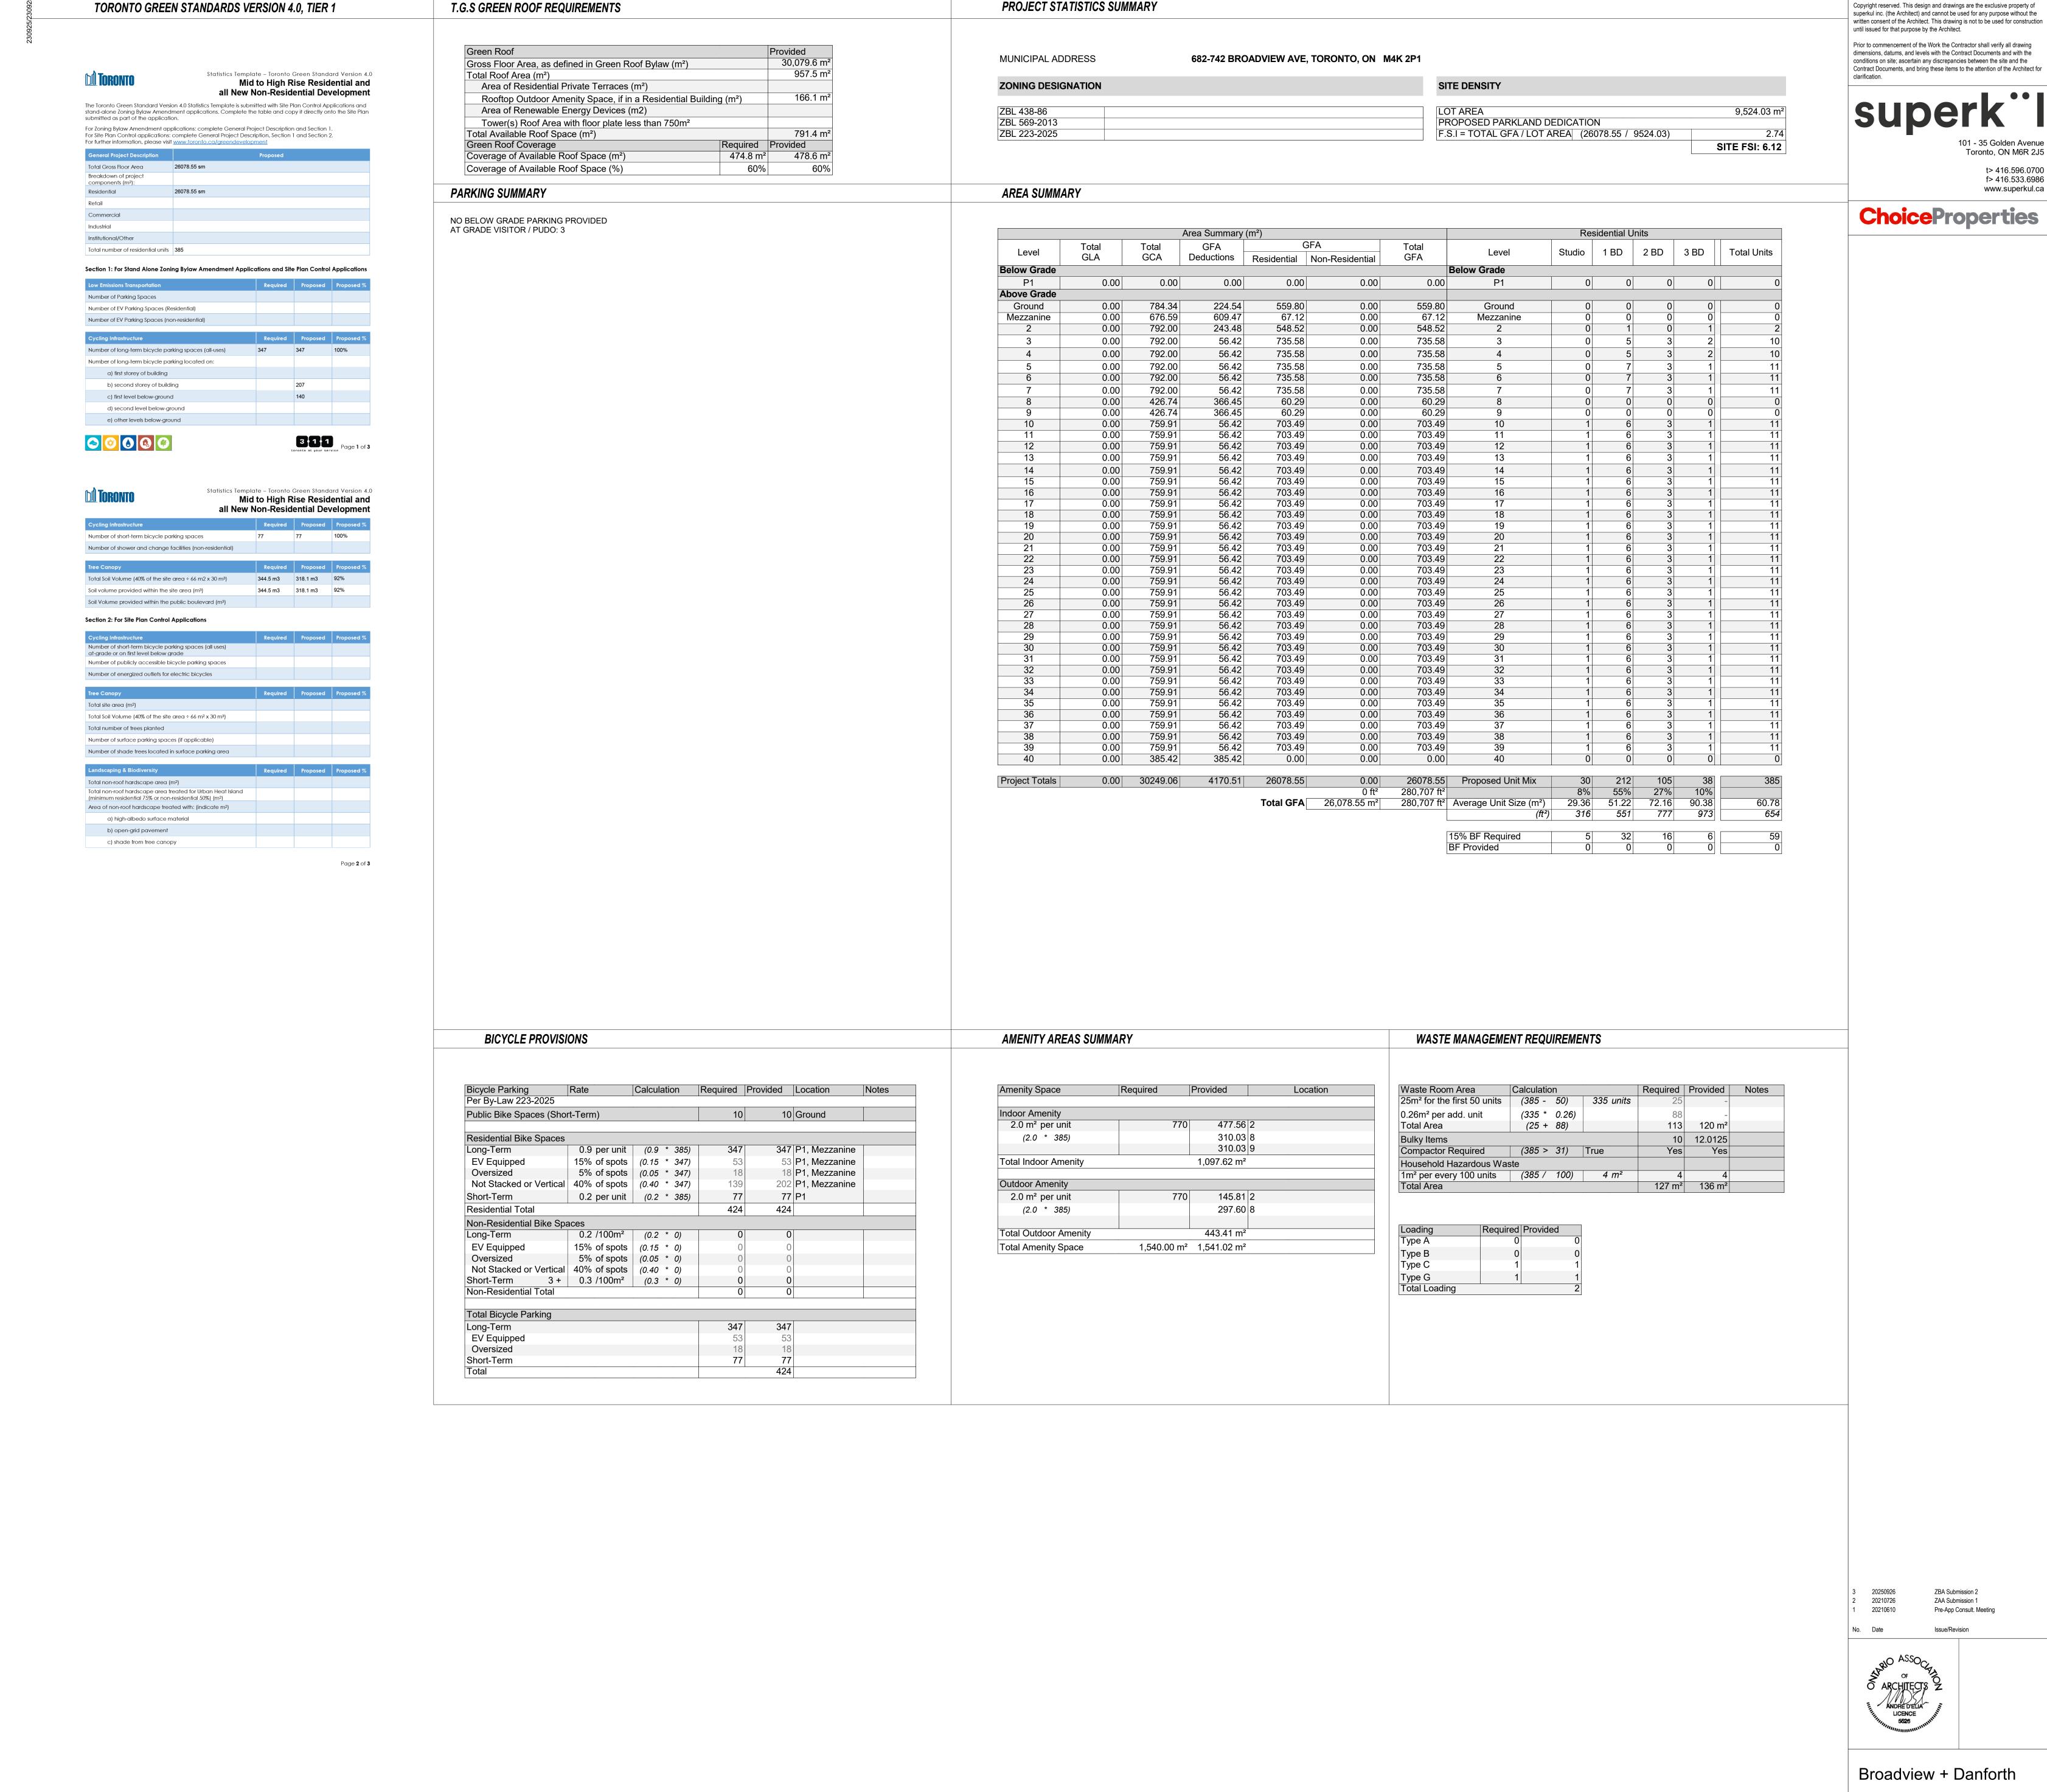
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Project Statistics - Building

Project No. 2017



PROJECT STATISTICS SUMMARY

T.G.S GREEN ROOF REQUIREMENTS

TORONTO GREEN STANDARDS VERSION 4.0, TIER 1

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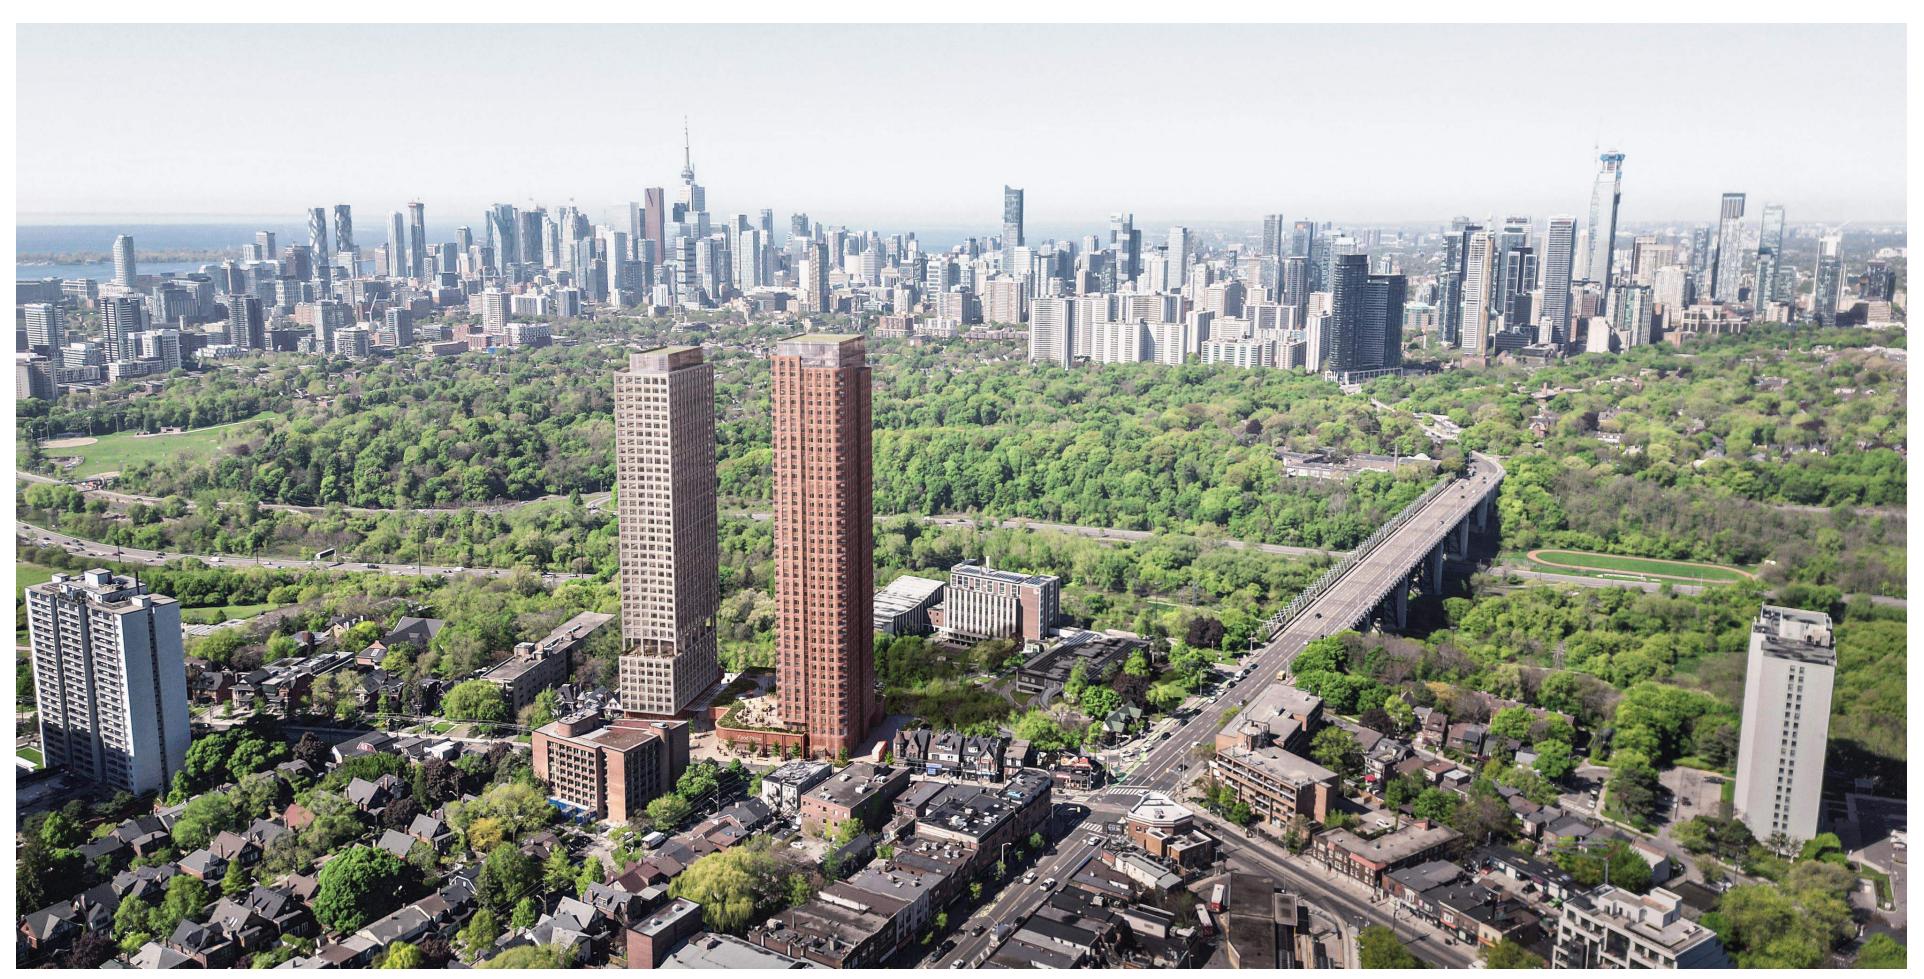
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Project Statistics - Building

Project No. 2017





VIEW FROM THE CORNER OF DEARBOURNE AVE AND BROADVIEW AVE

AERIAL VIEW OF PROJECT SITE LOOKING WEST



VIEW ALONG BROADVIEW AVE

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ChoiceProperties

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 20210610
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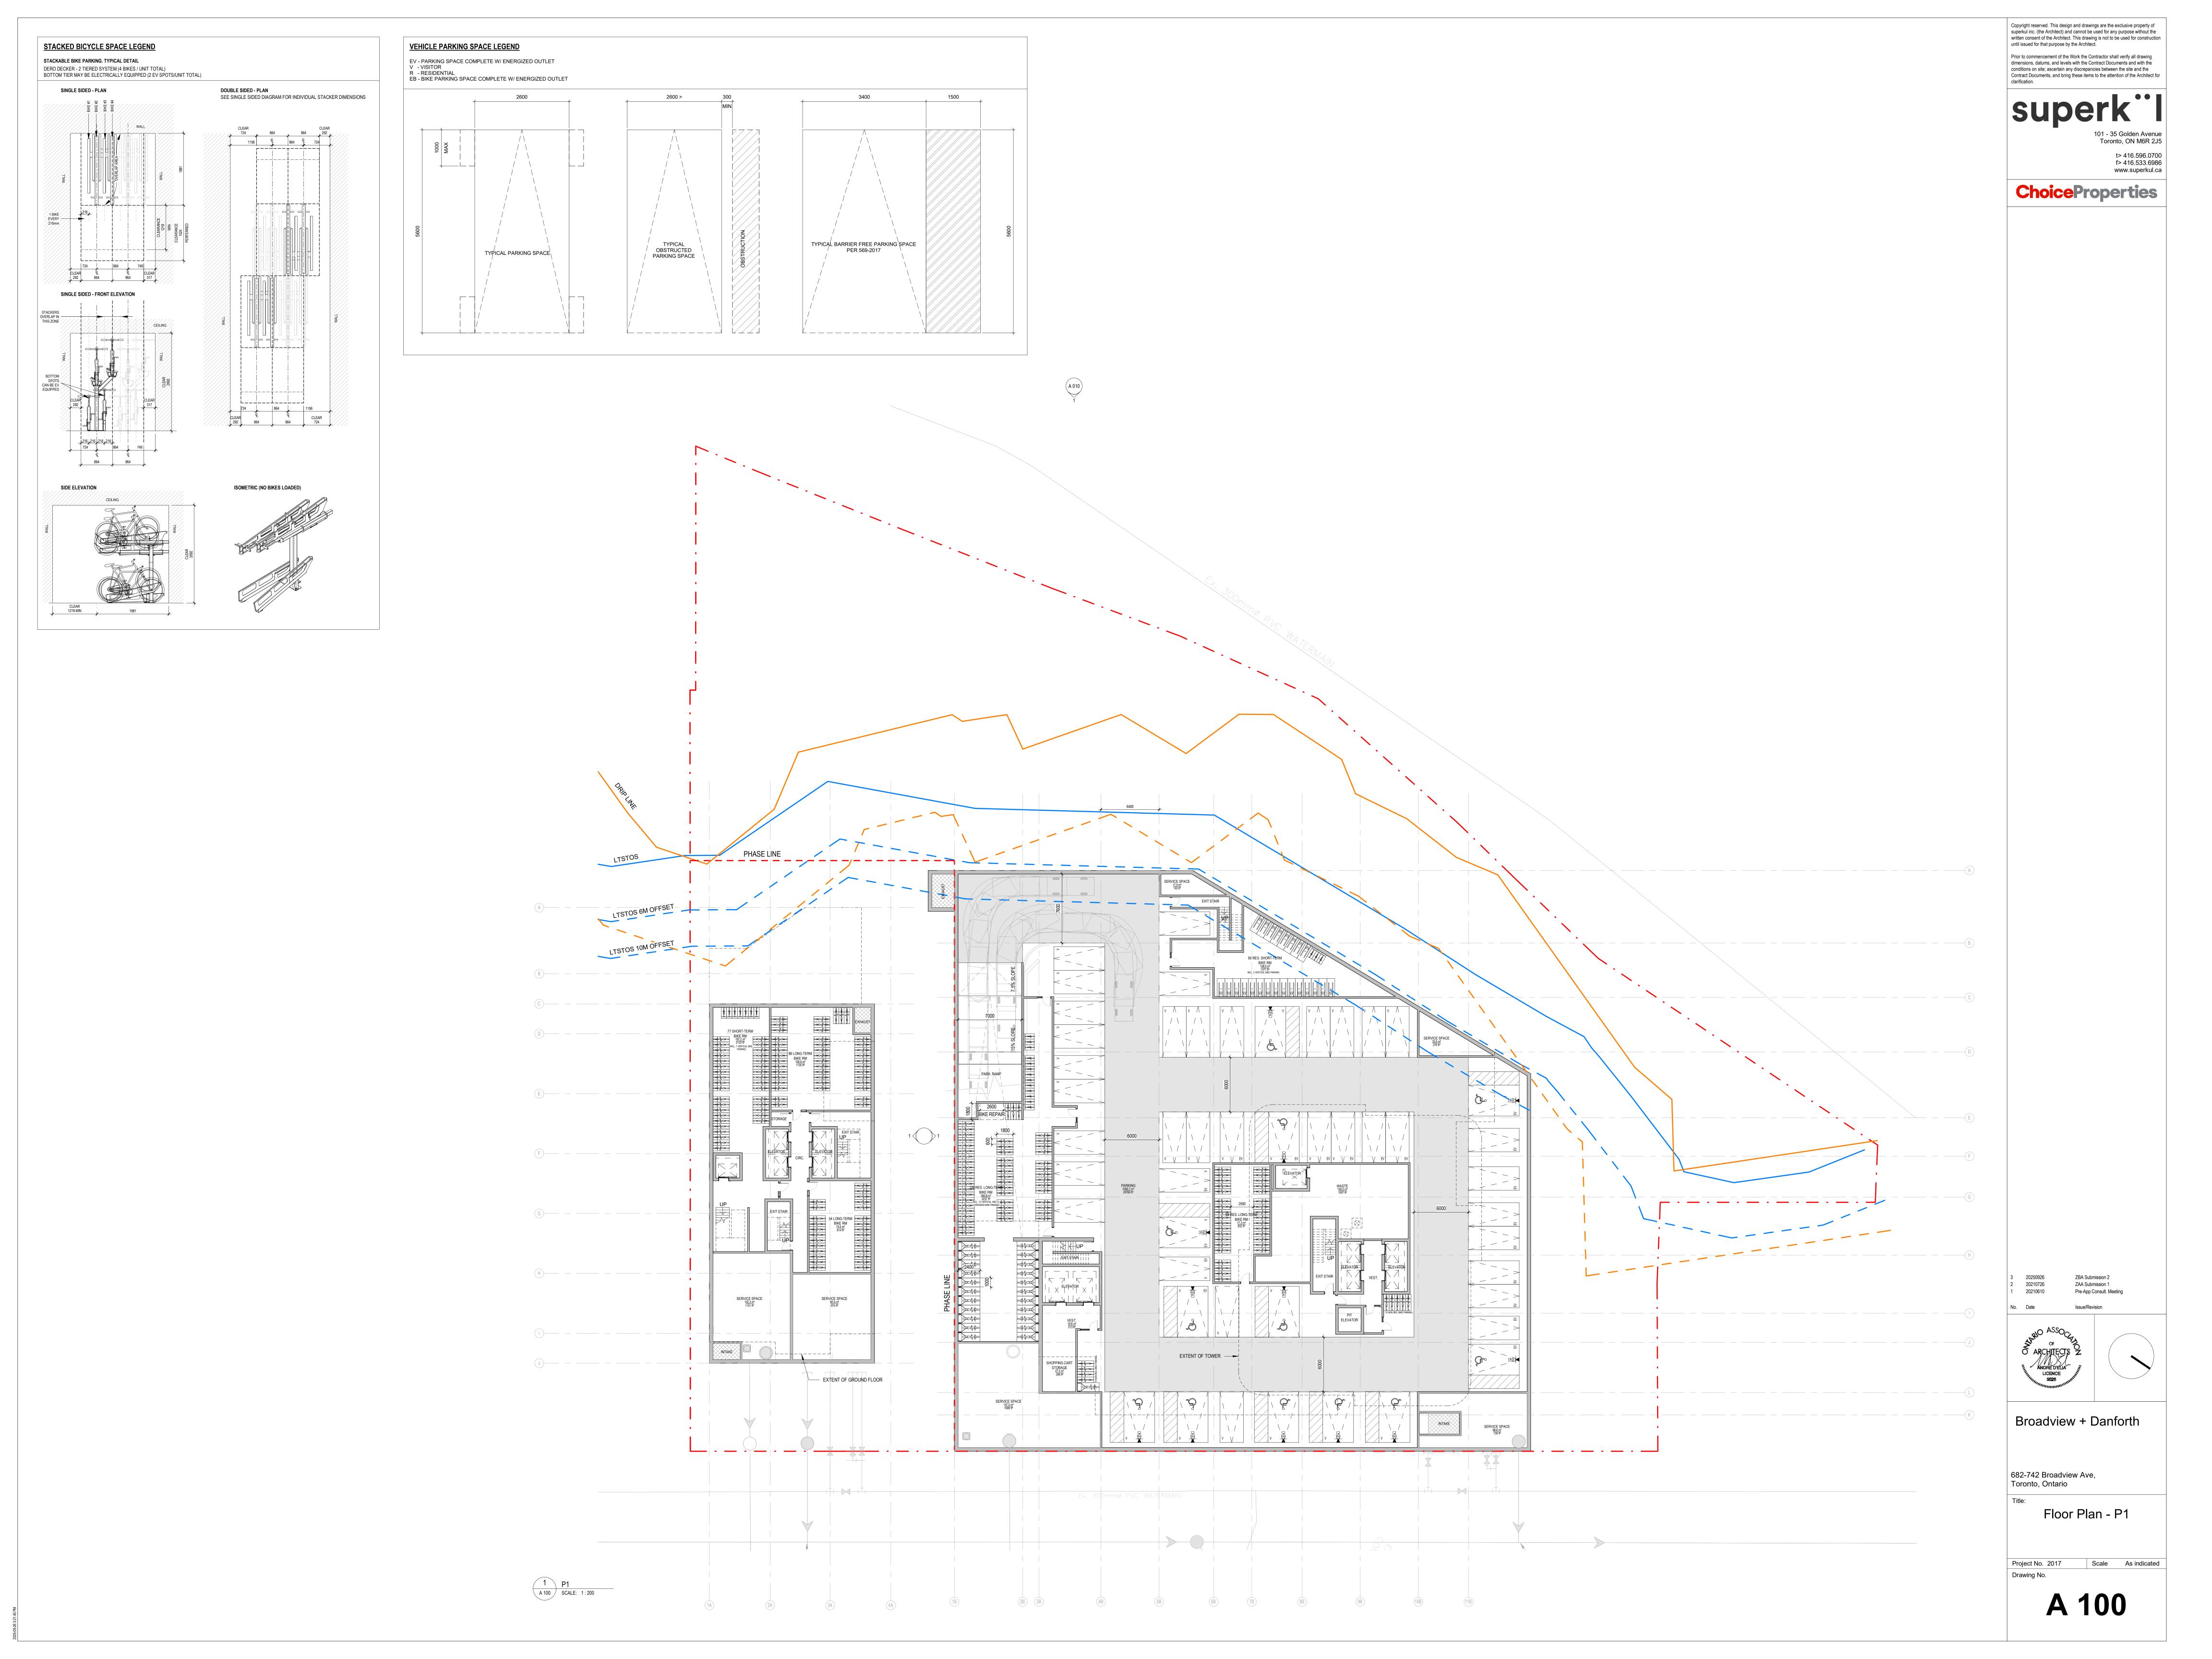



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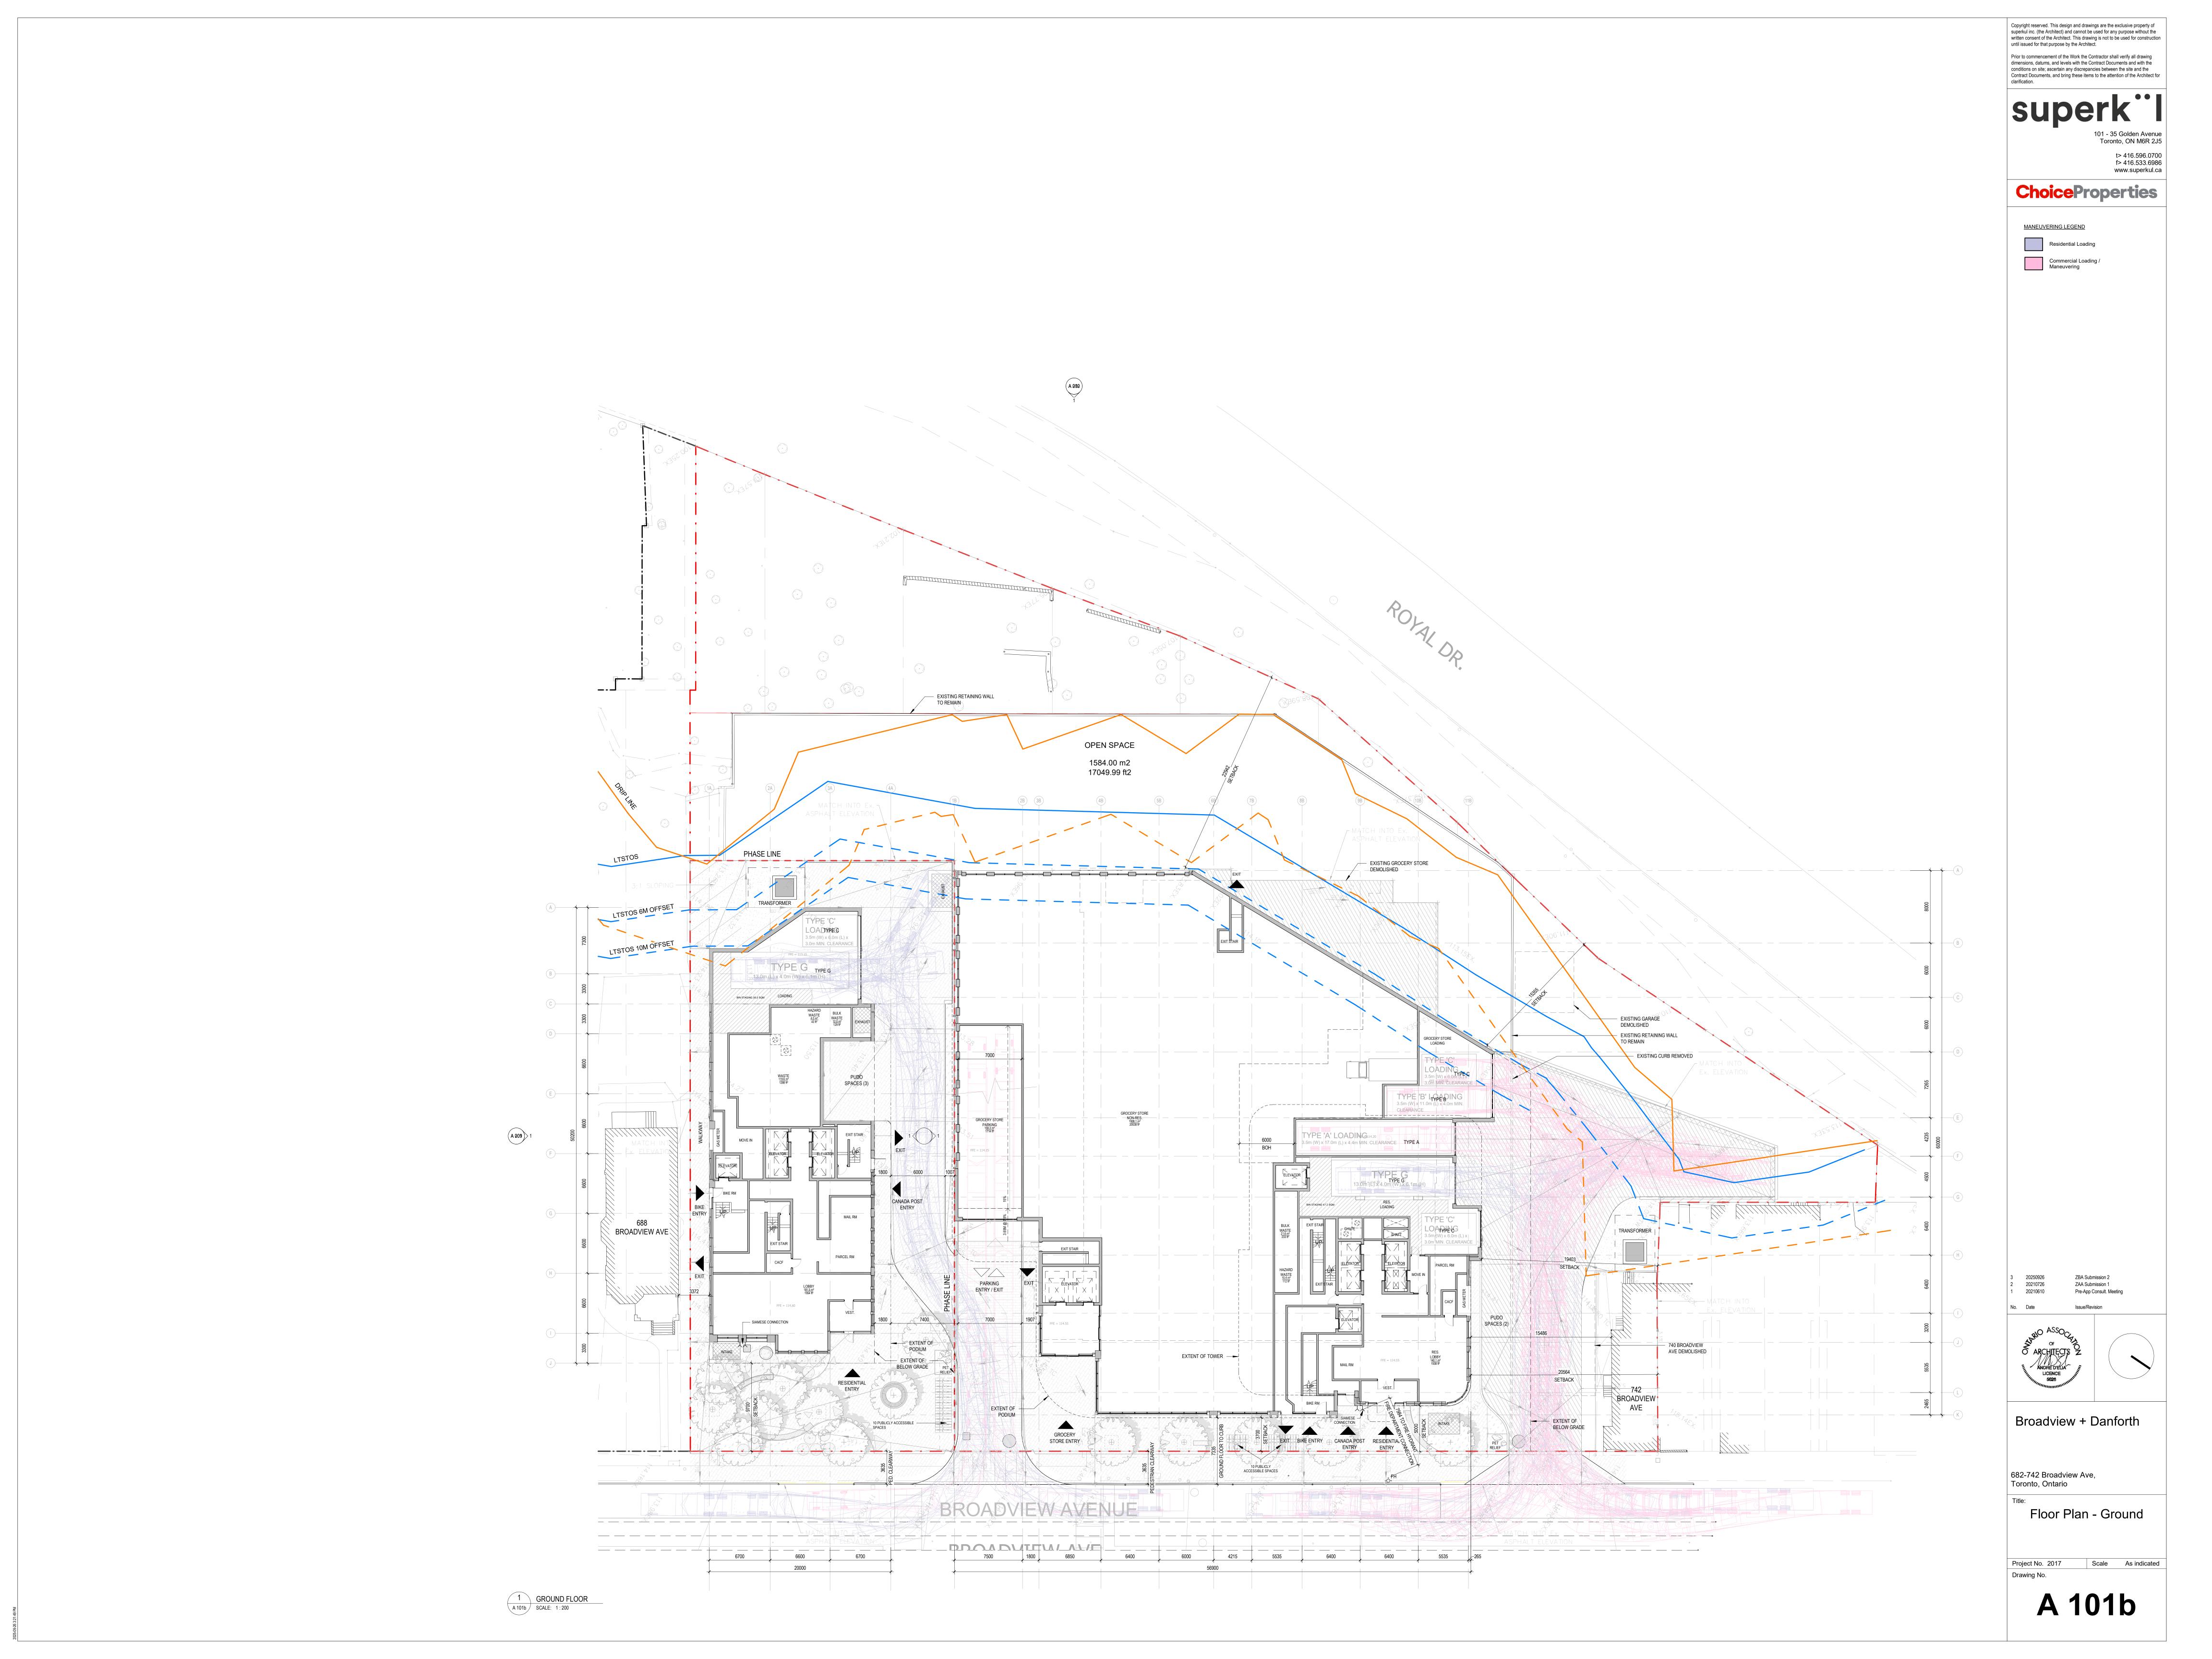
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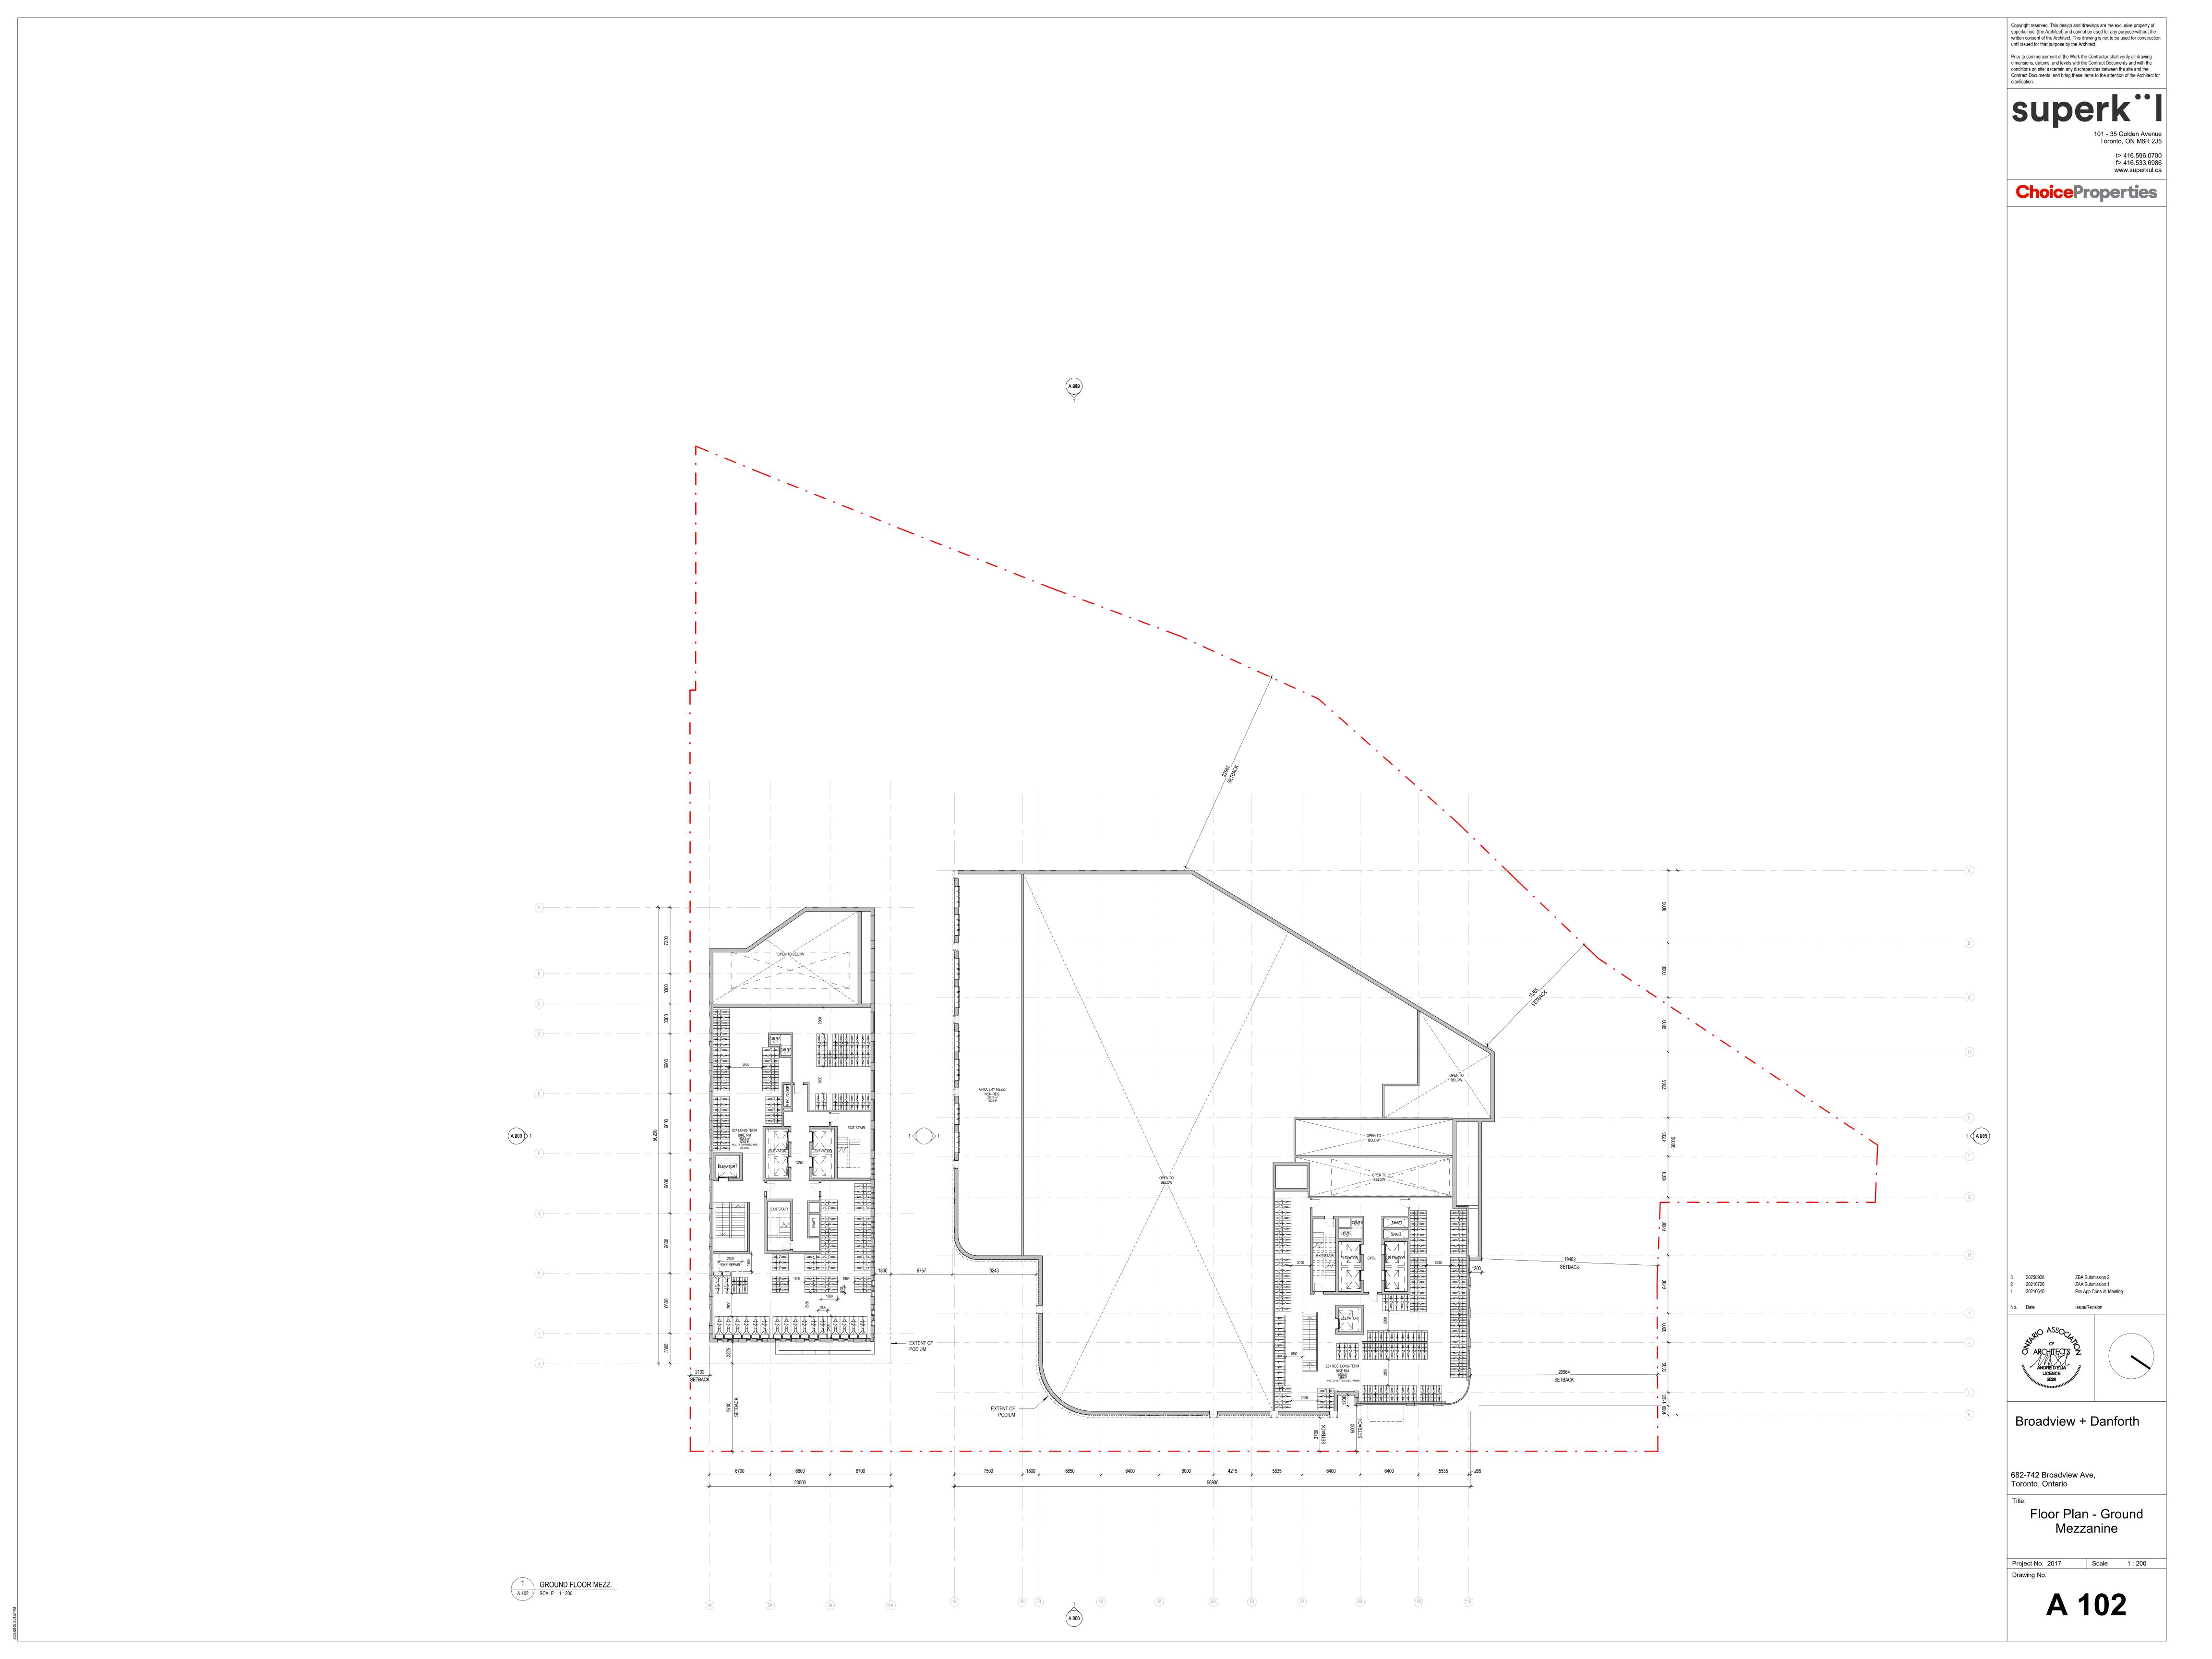
Perspective Views


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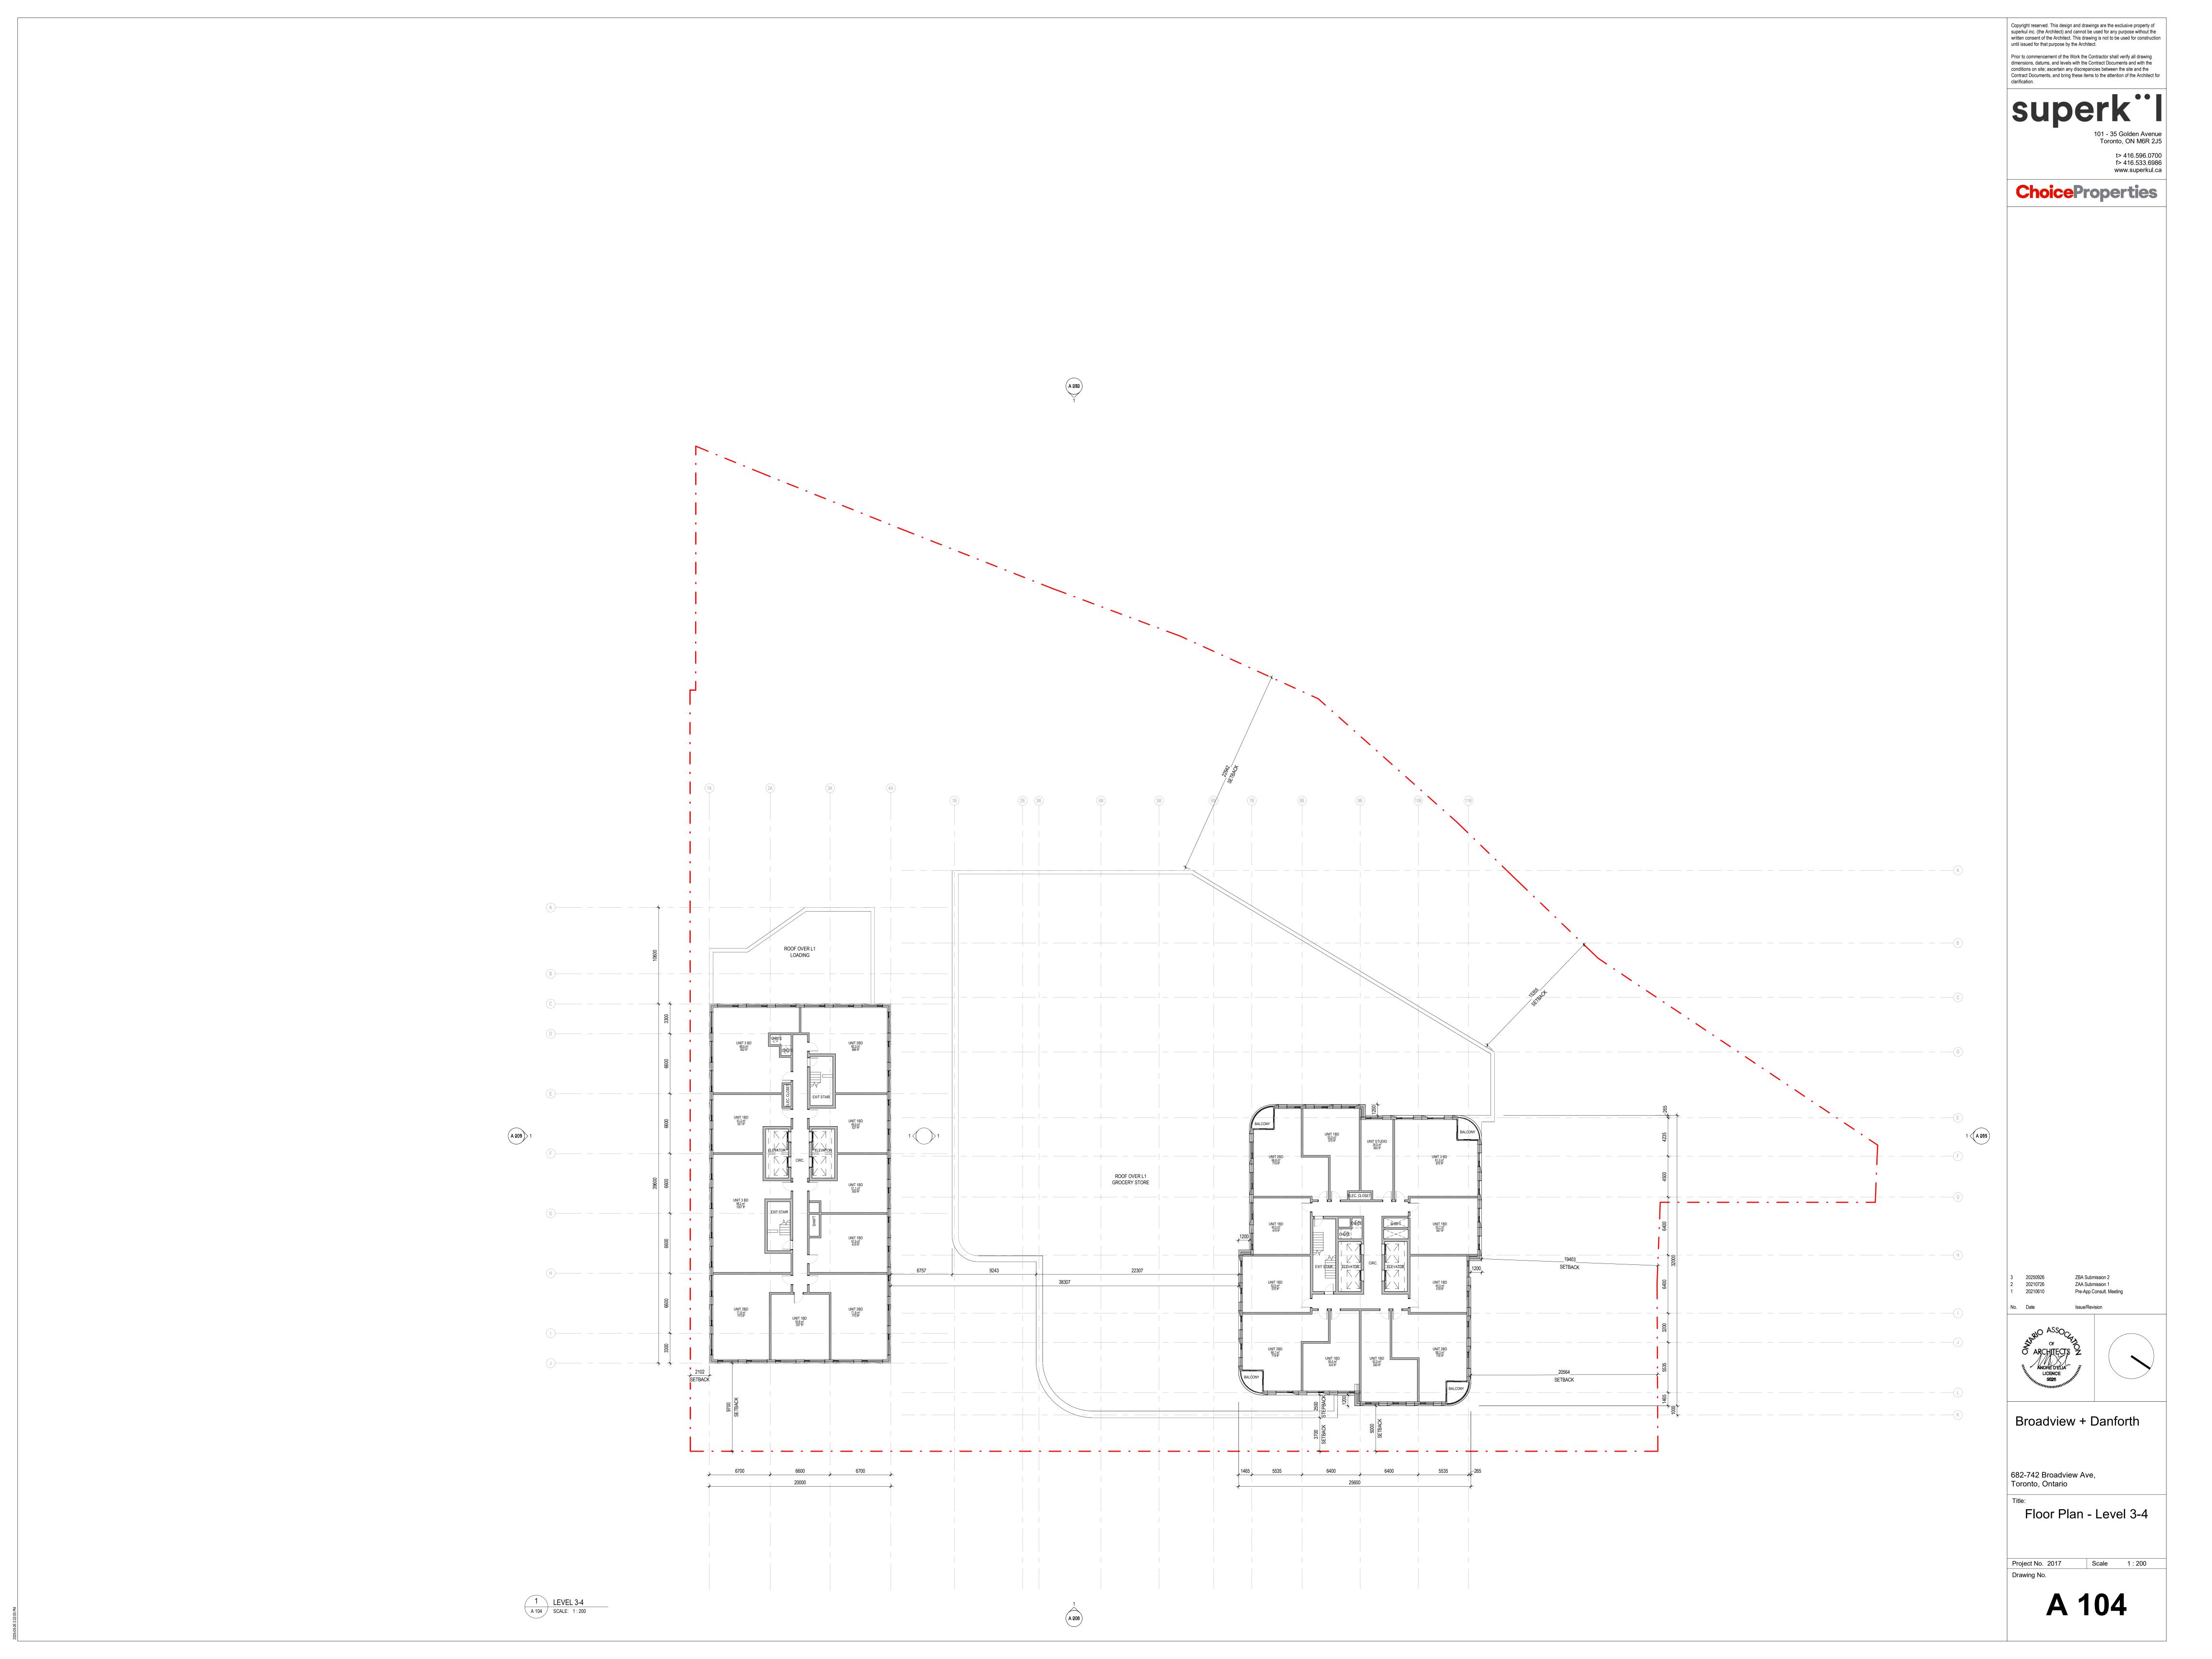










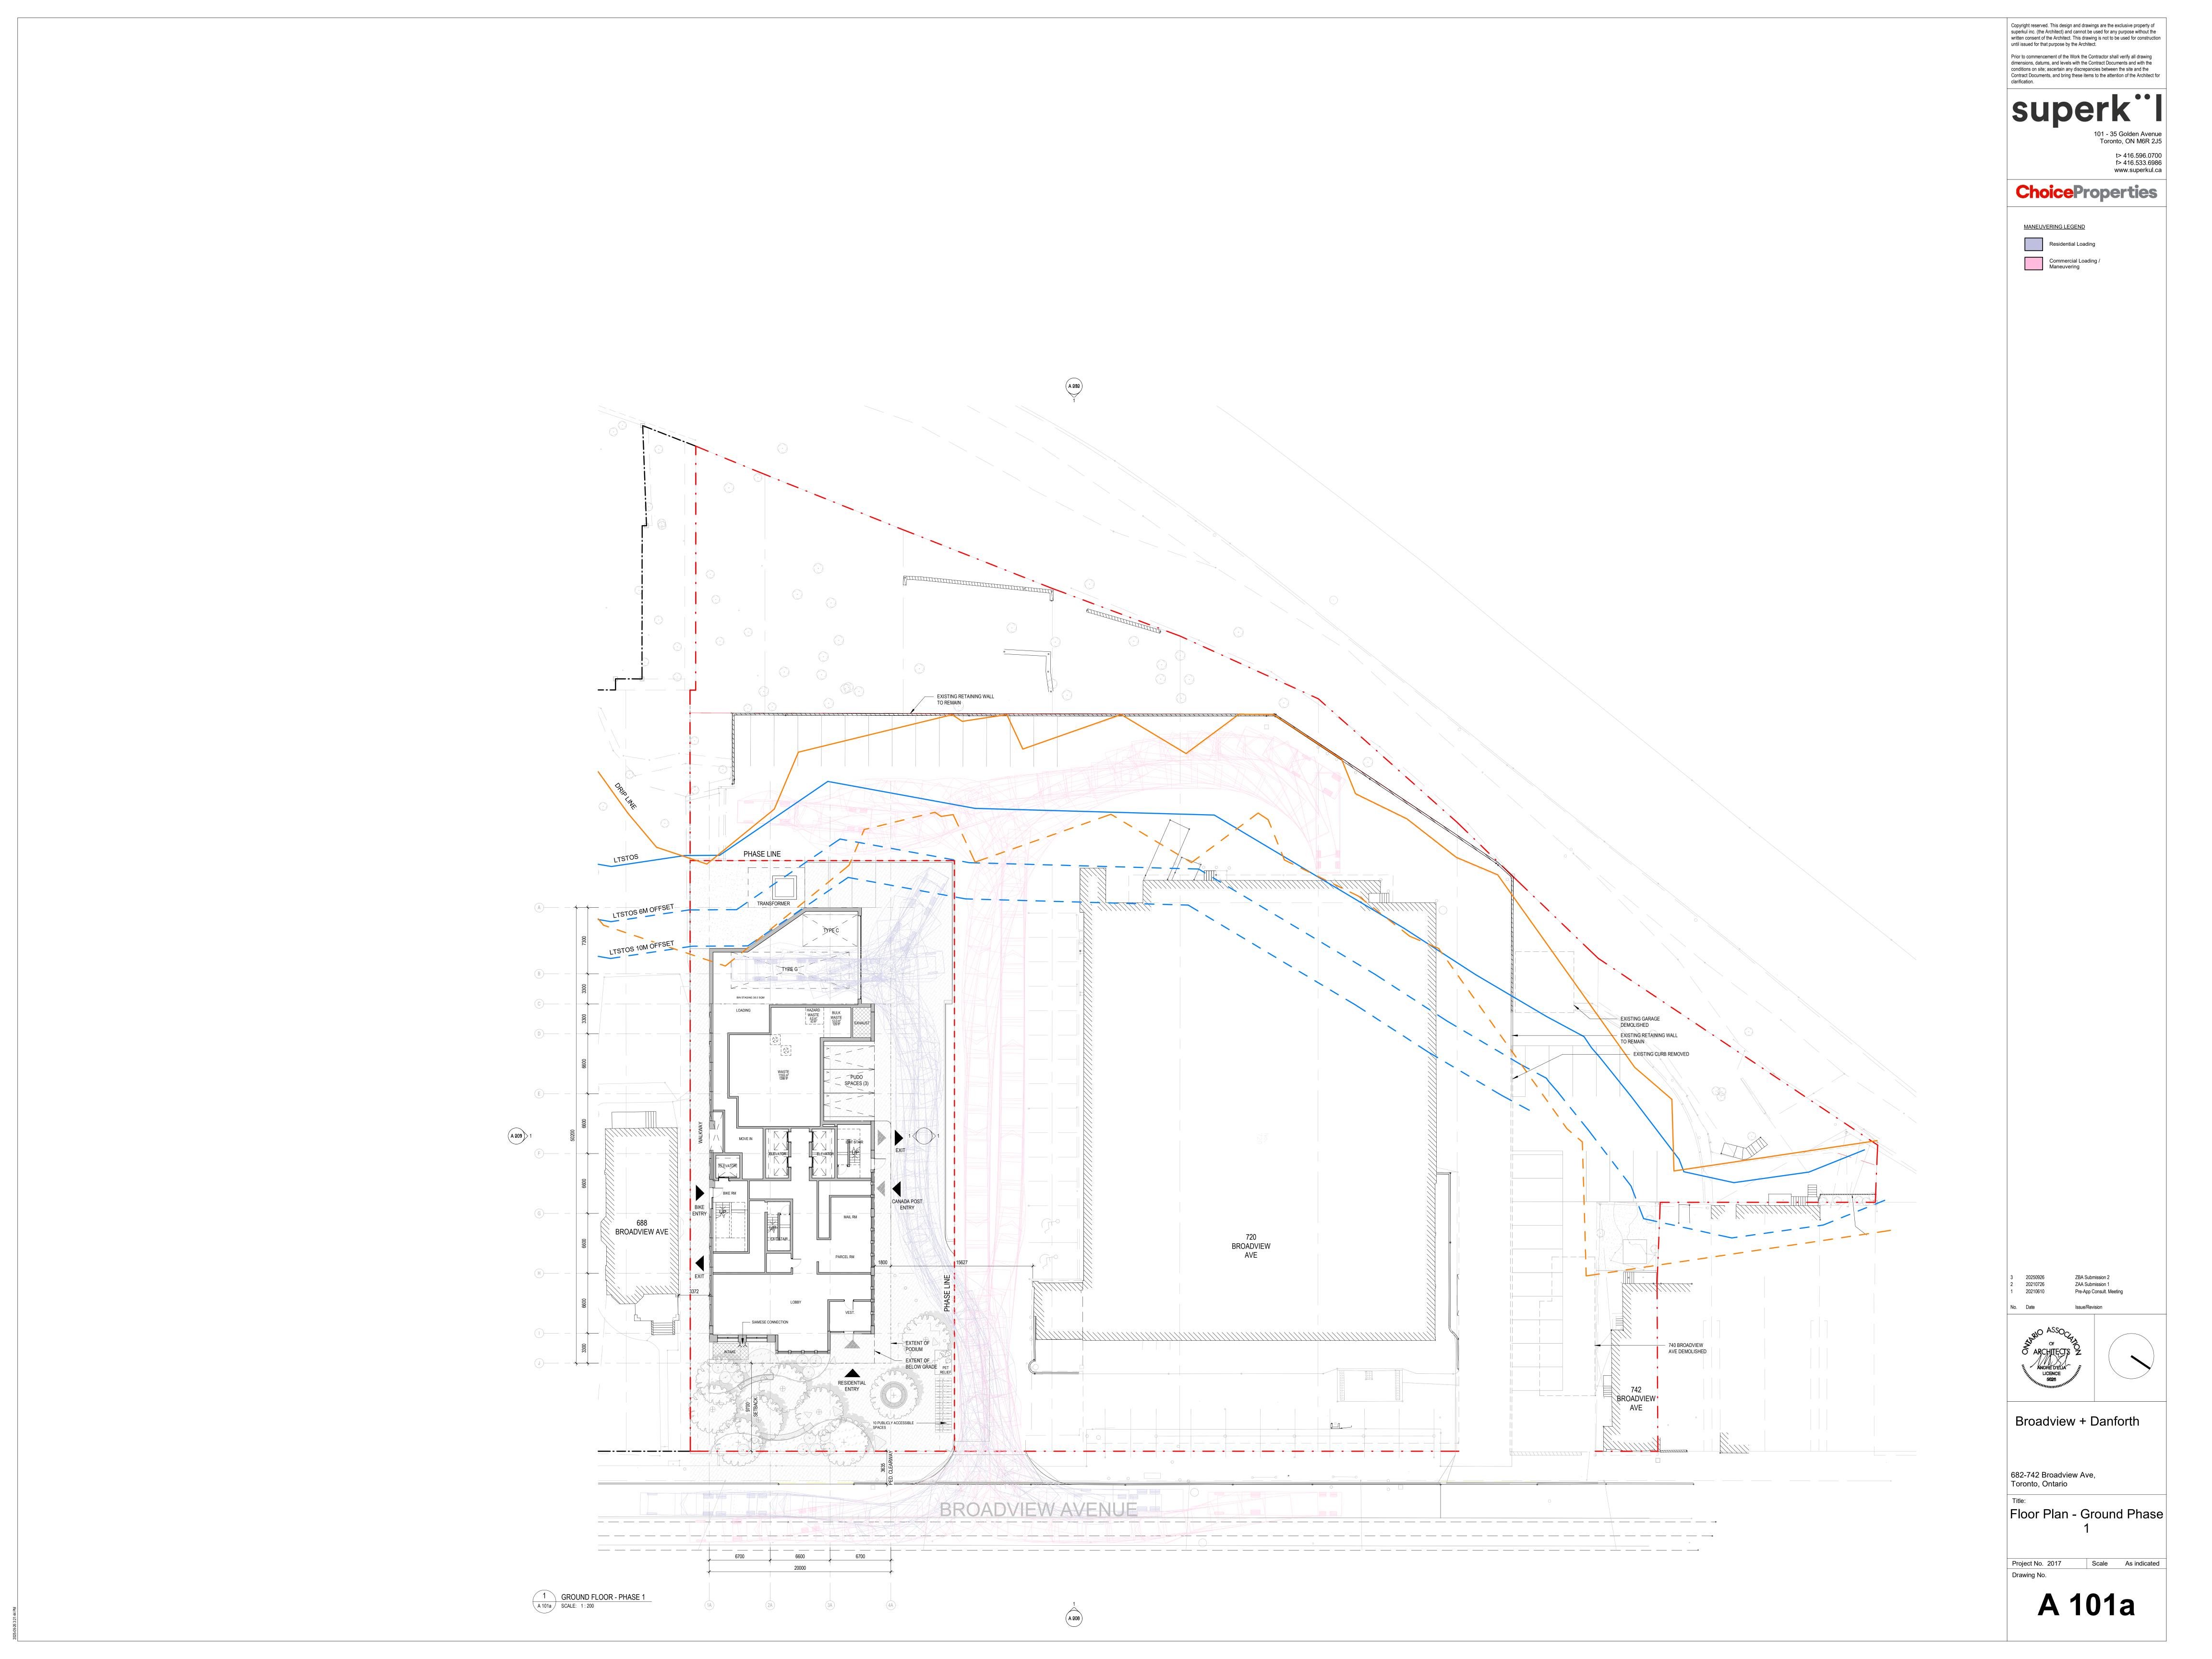


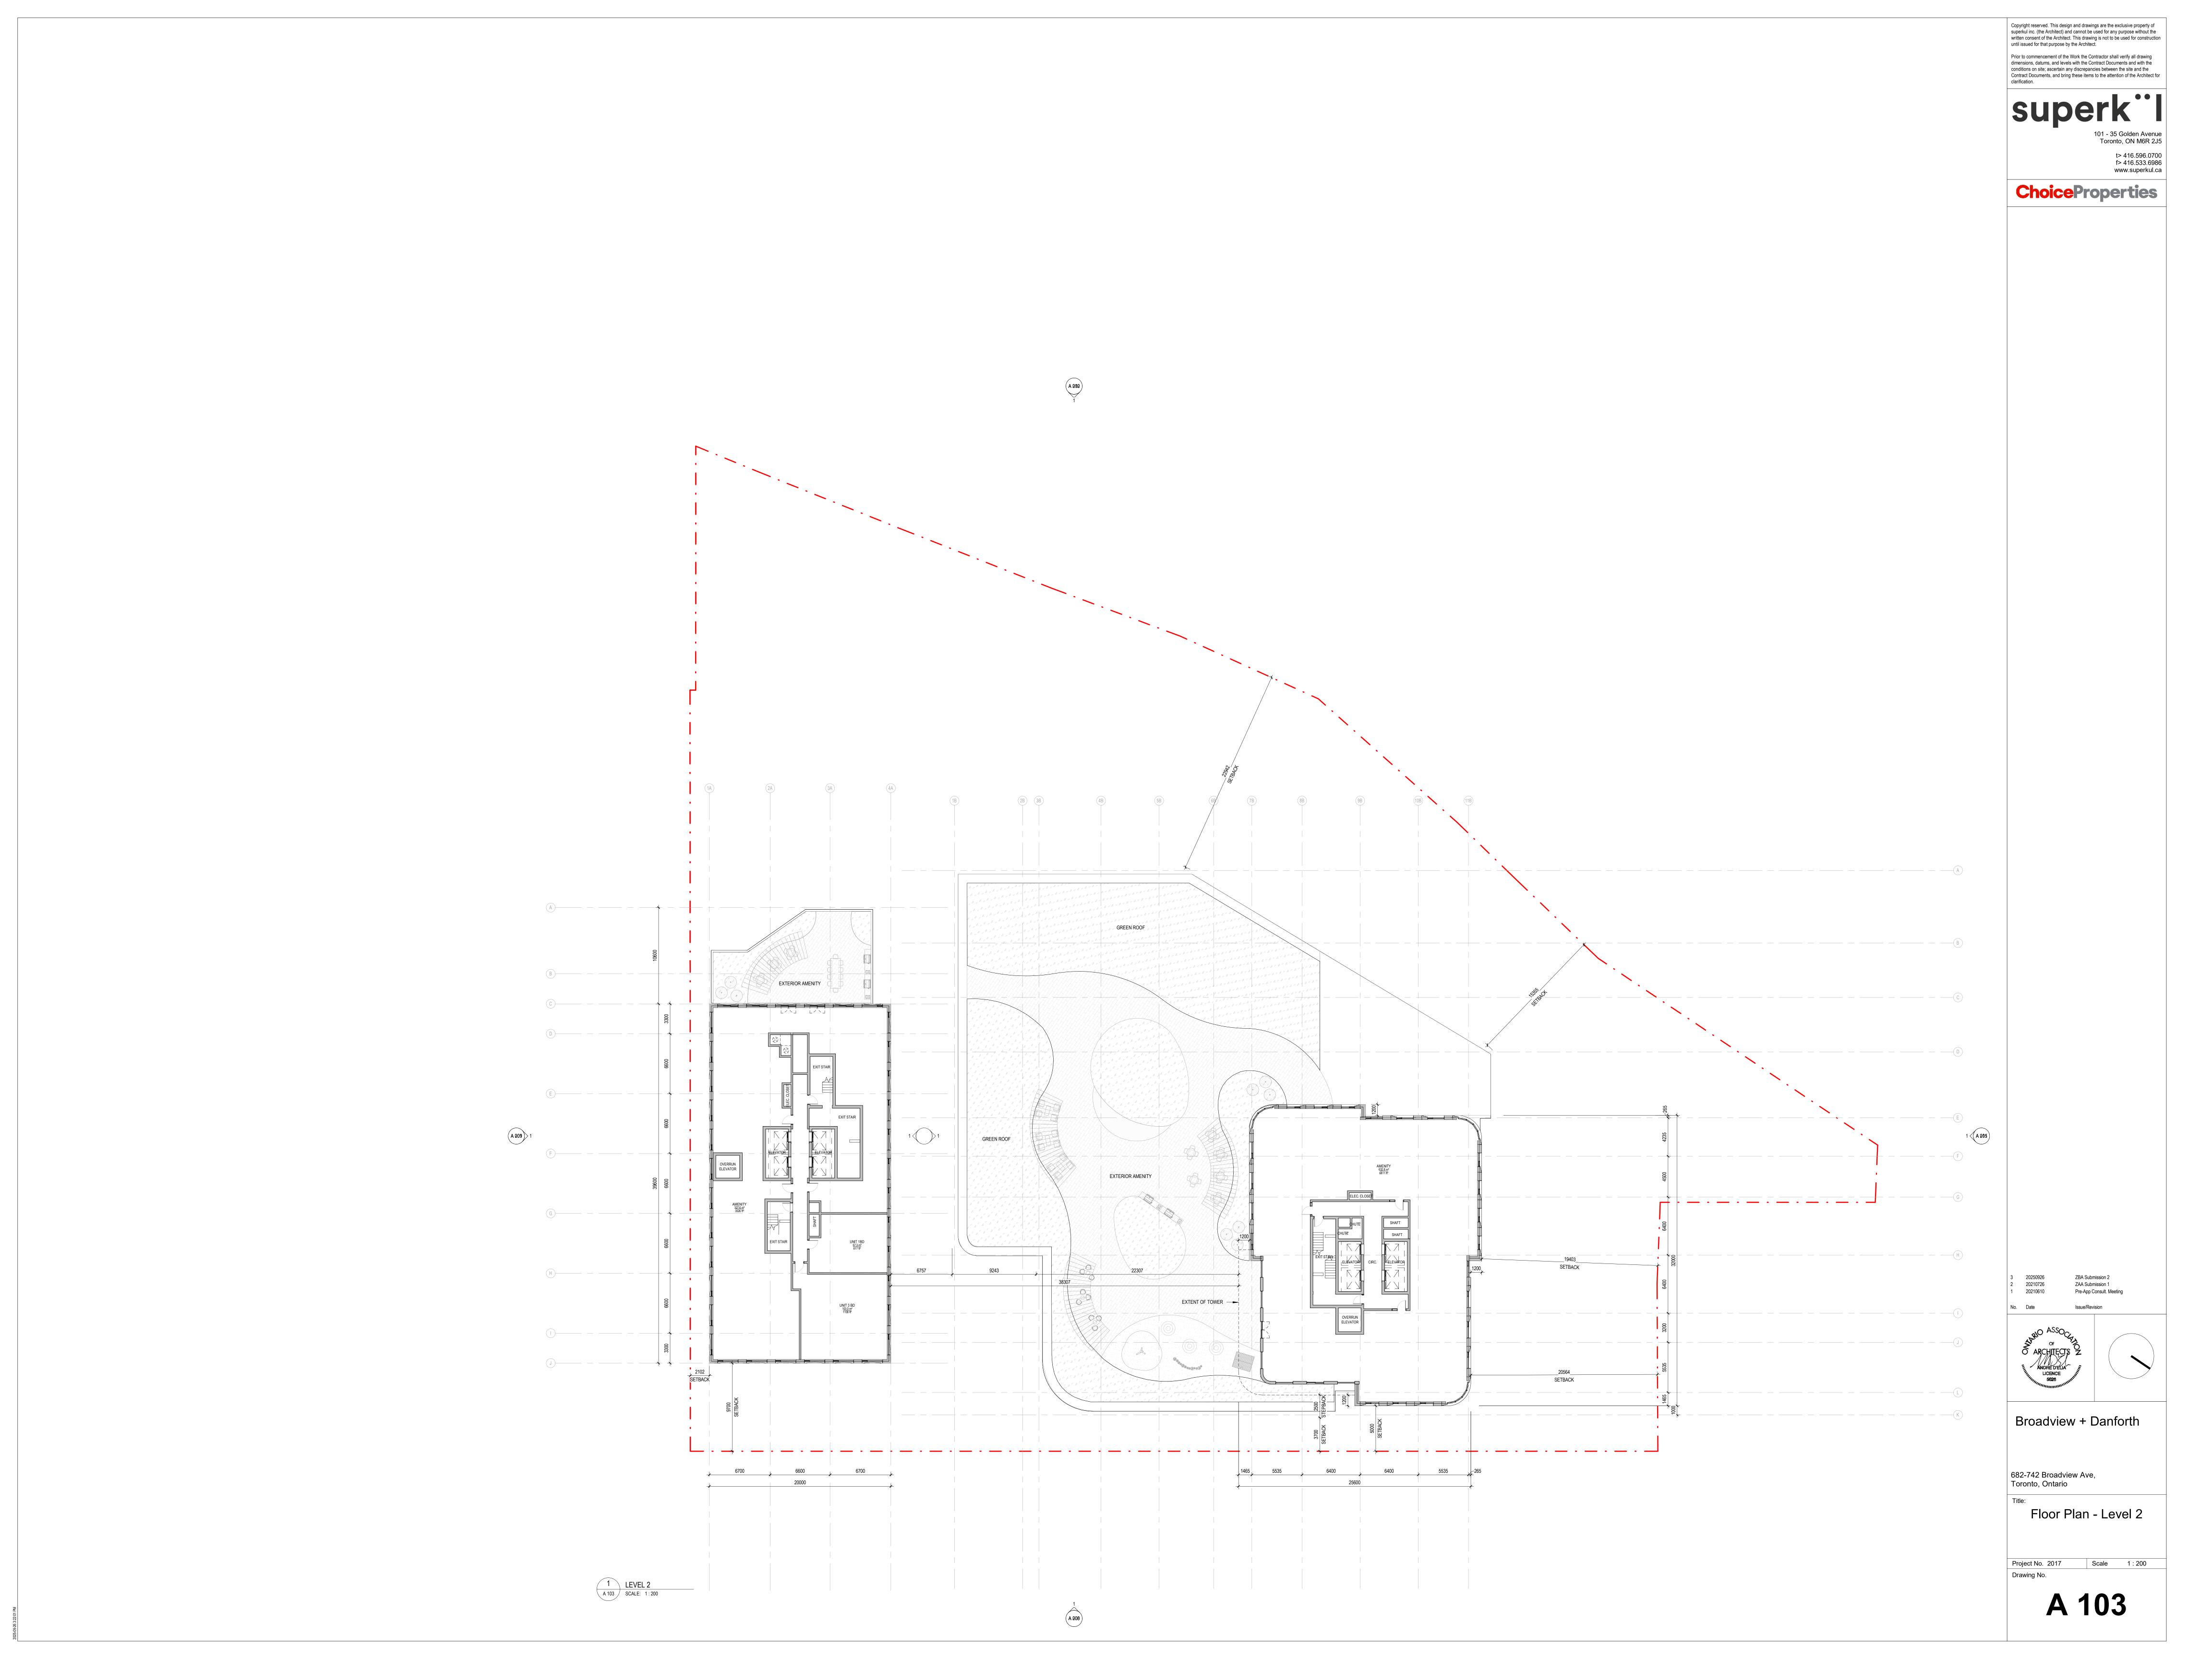





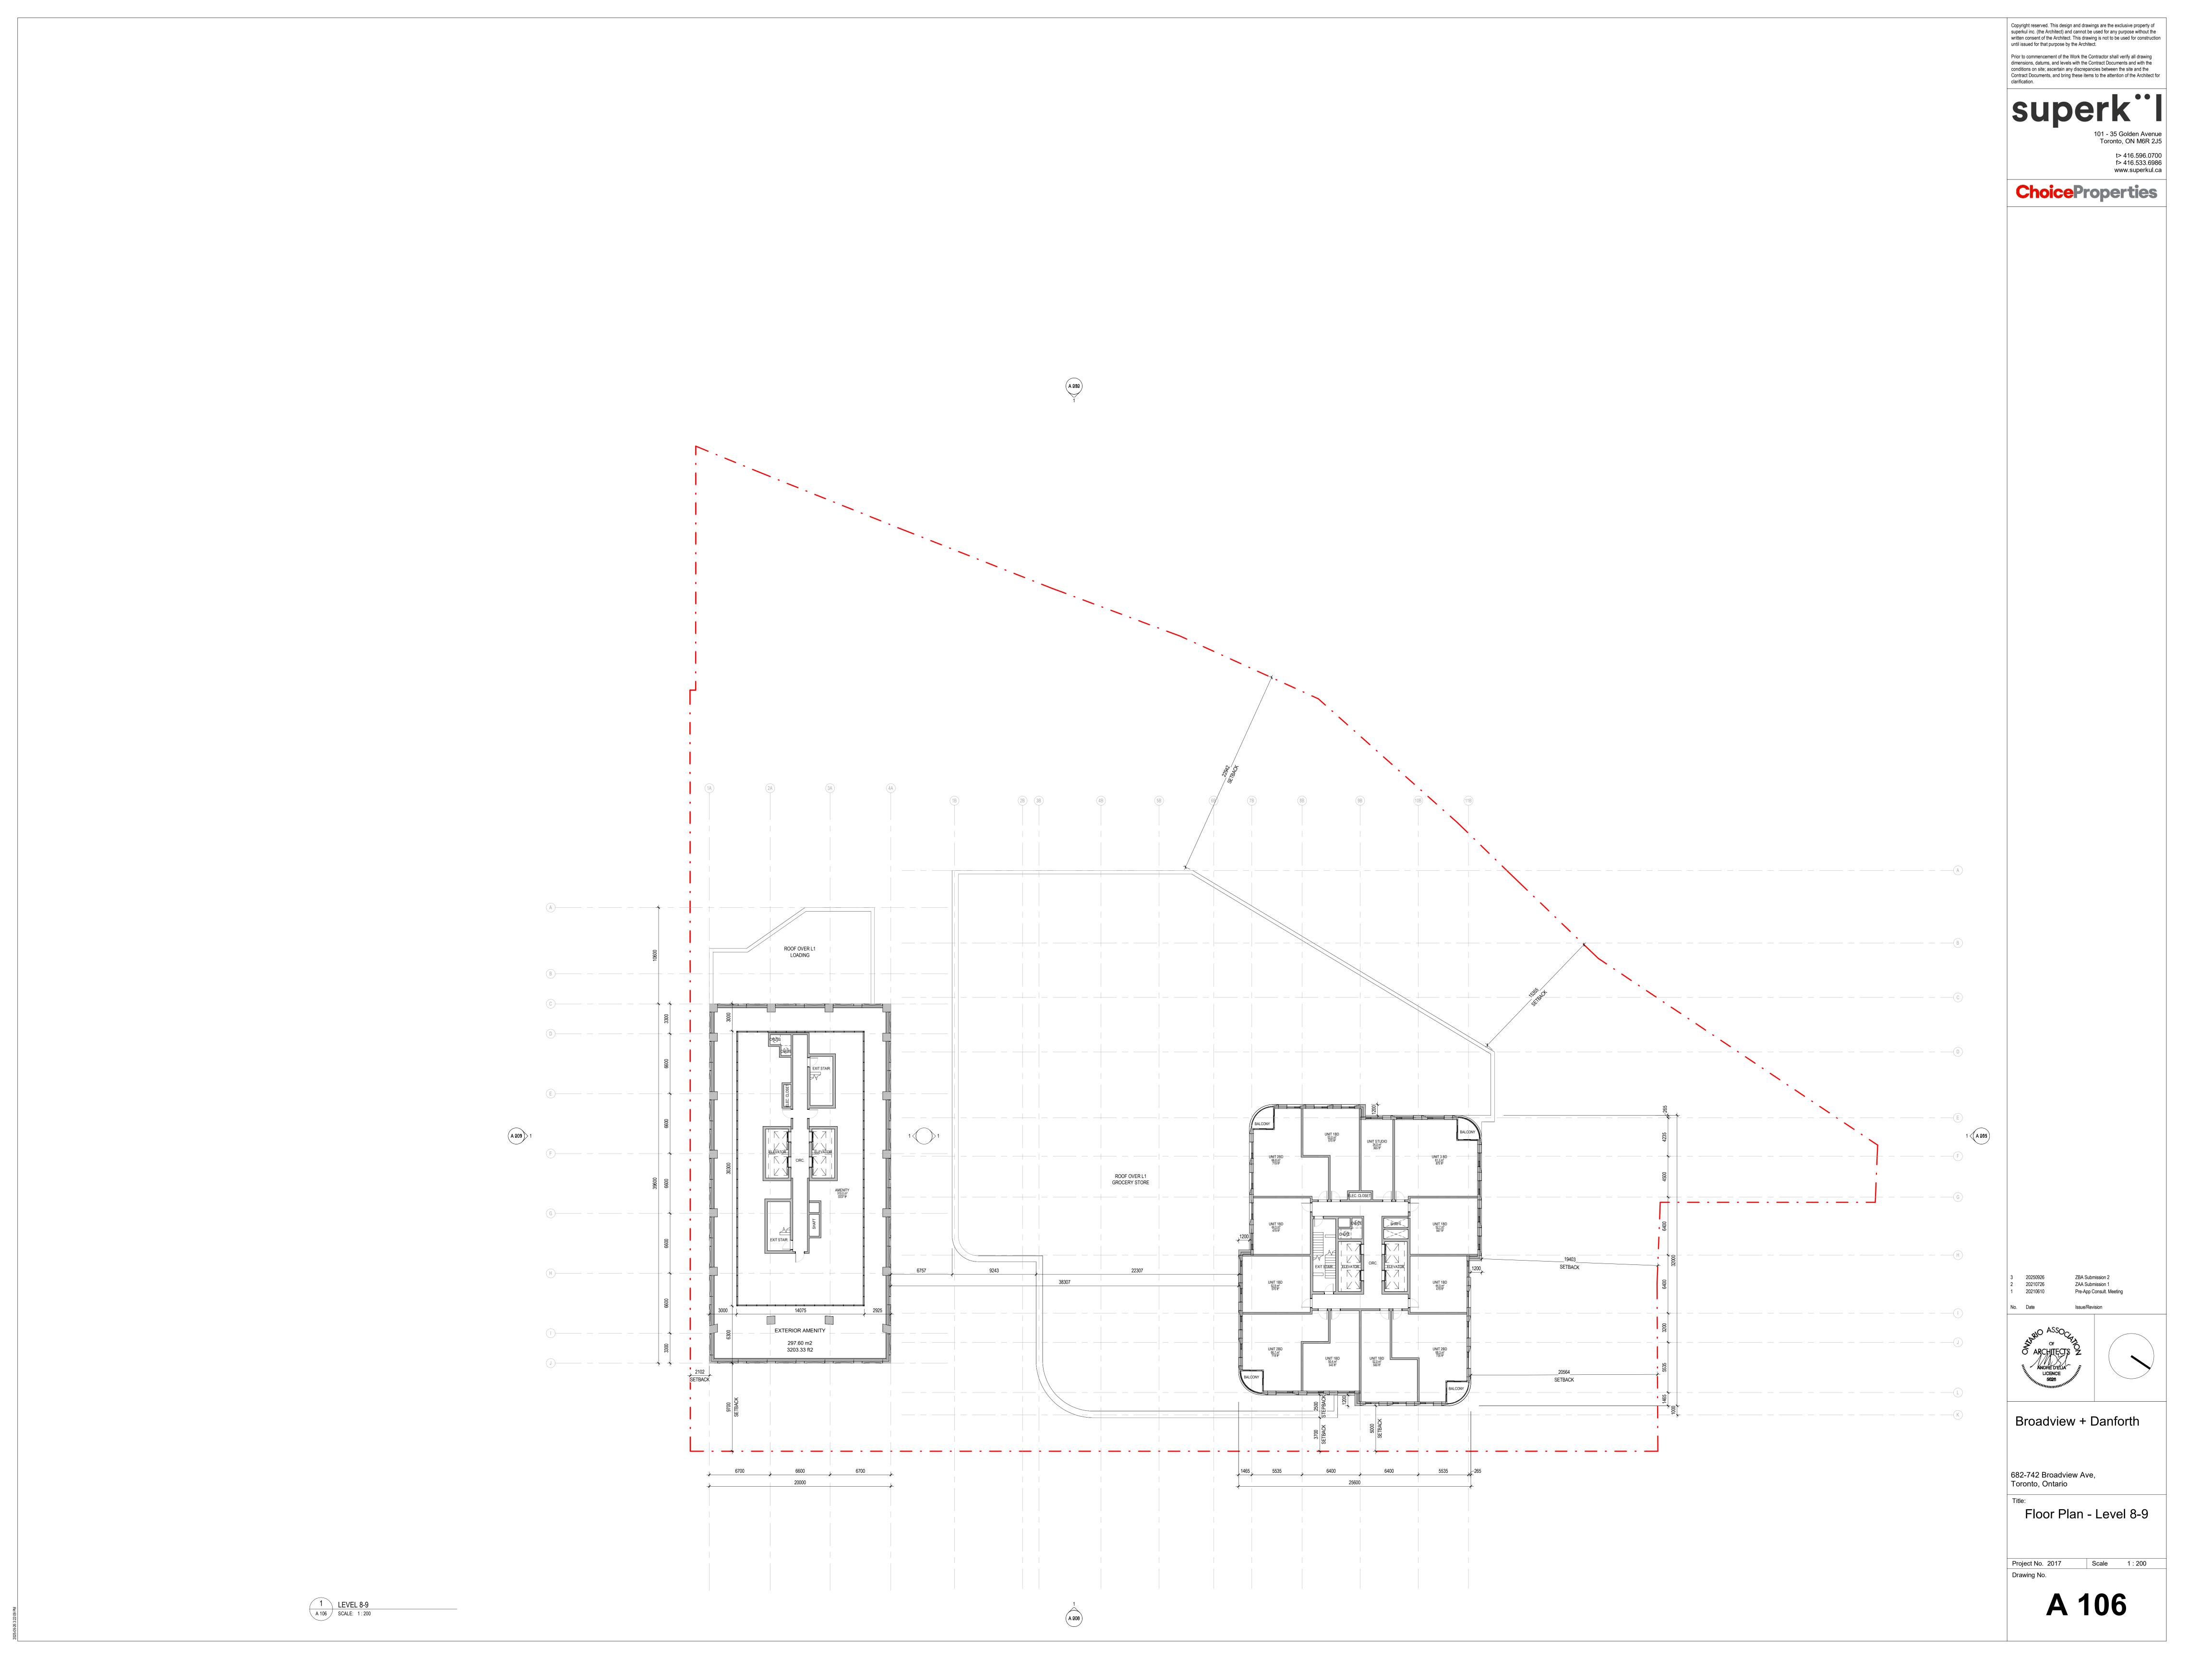


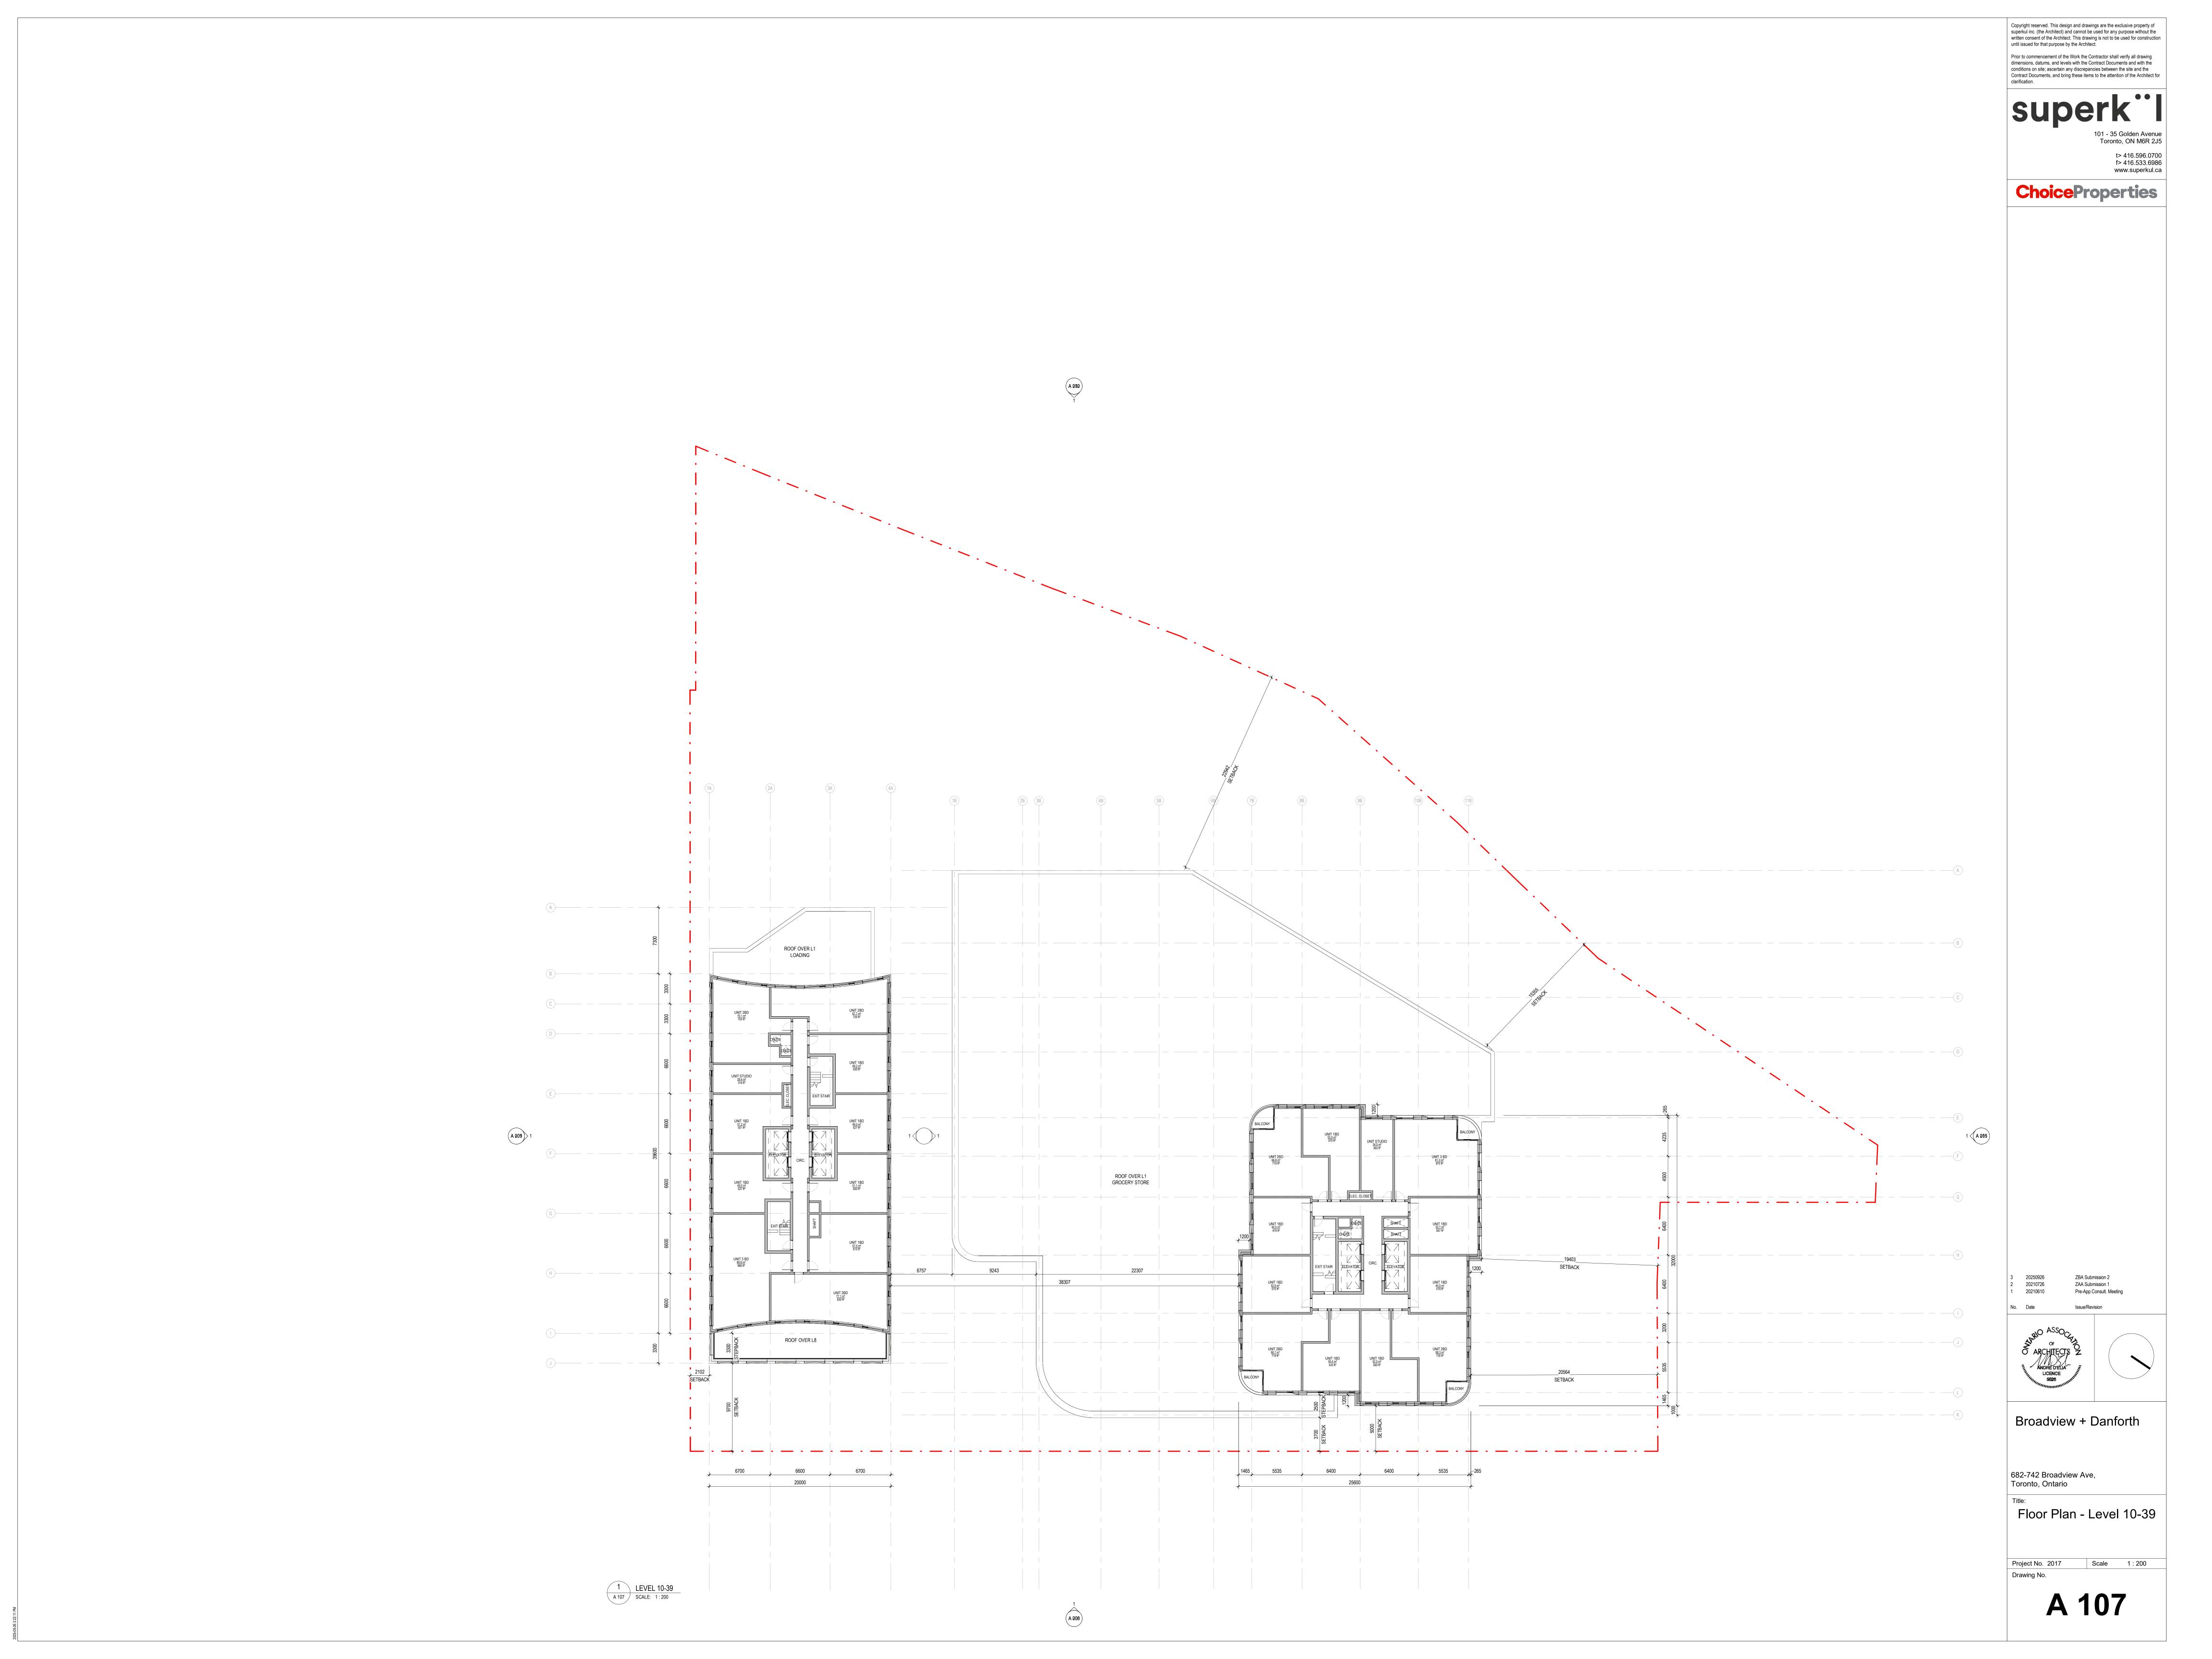

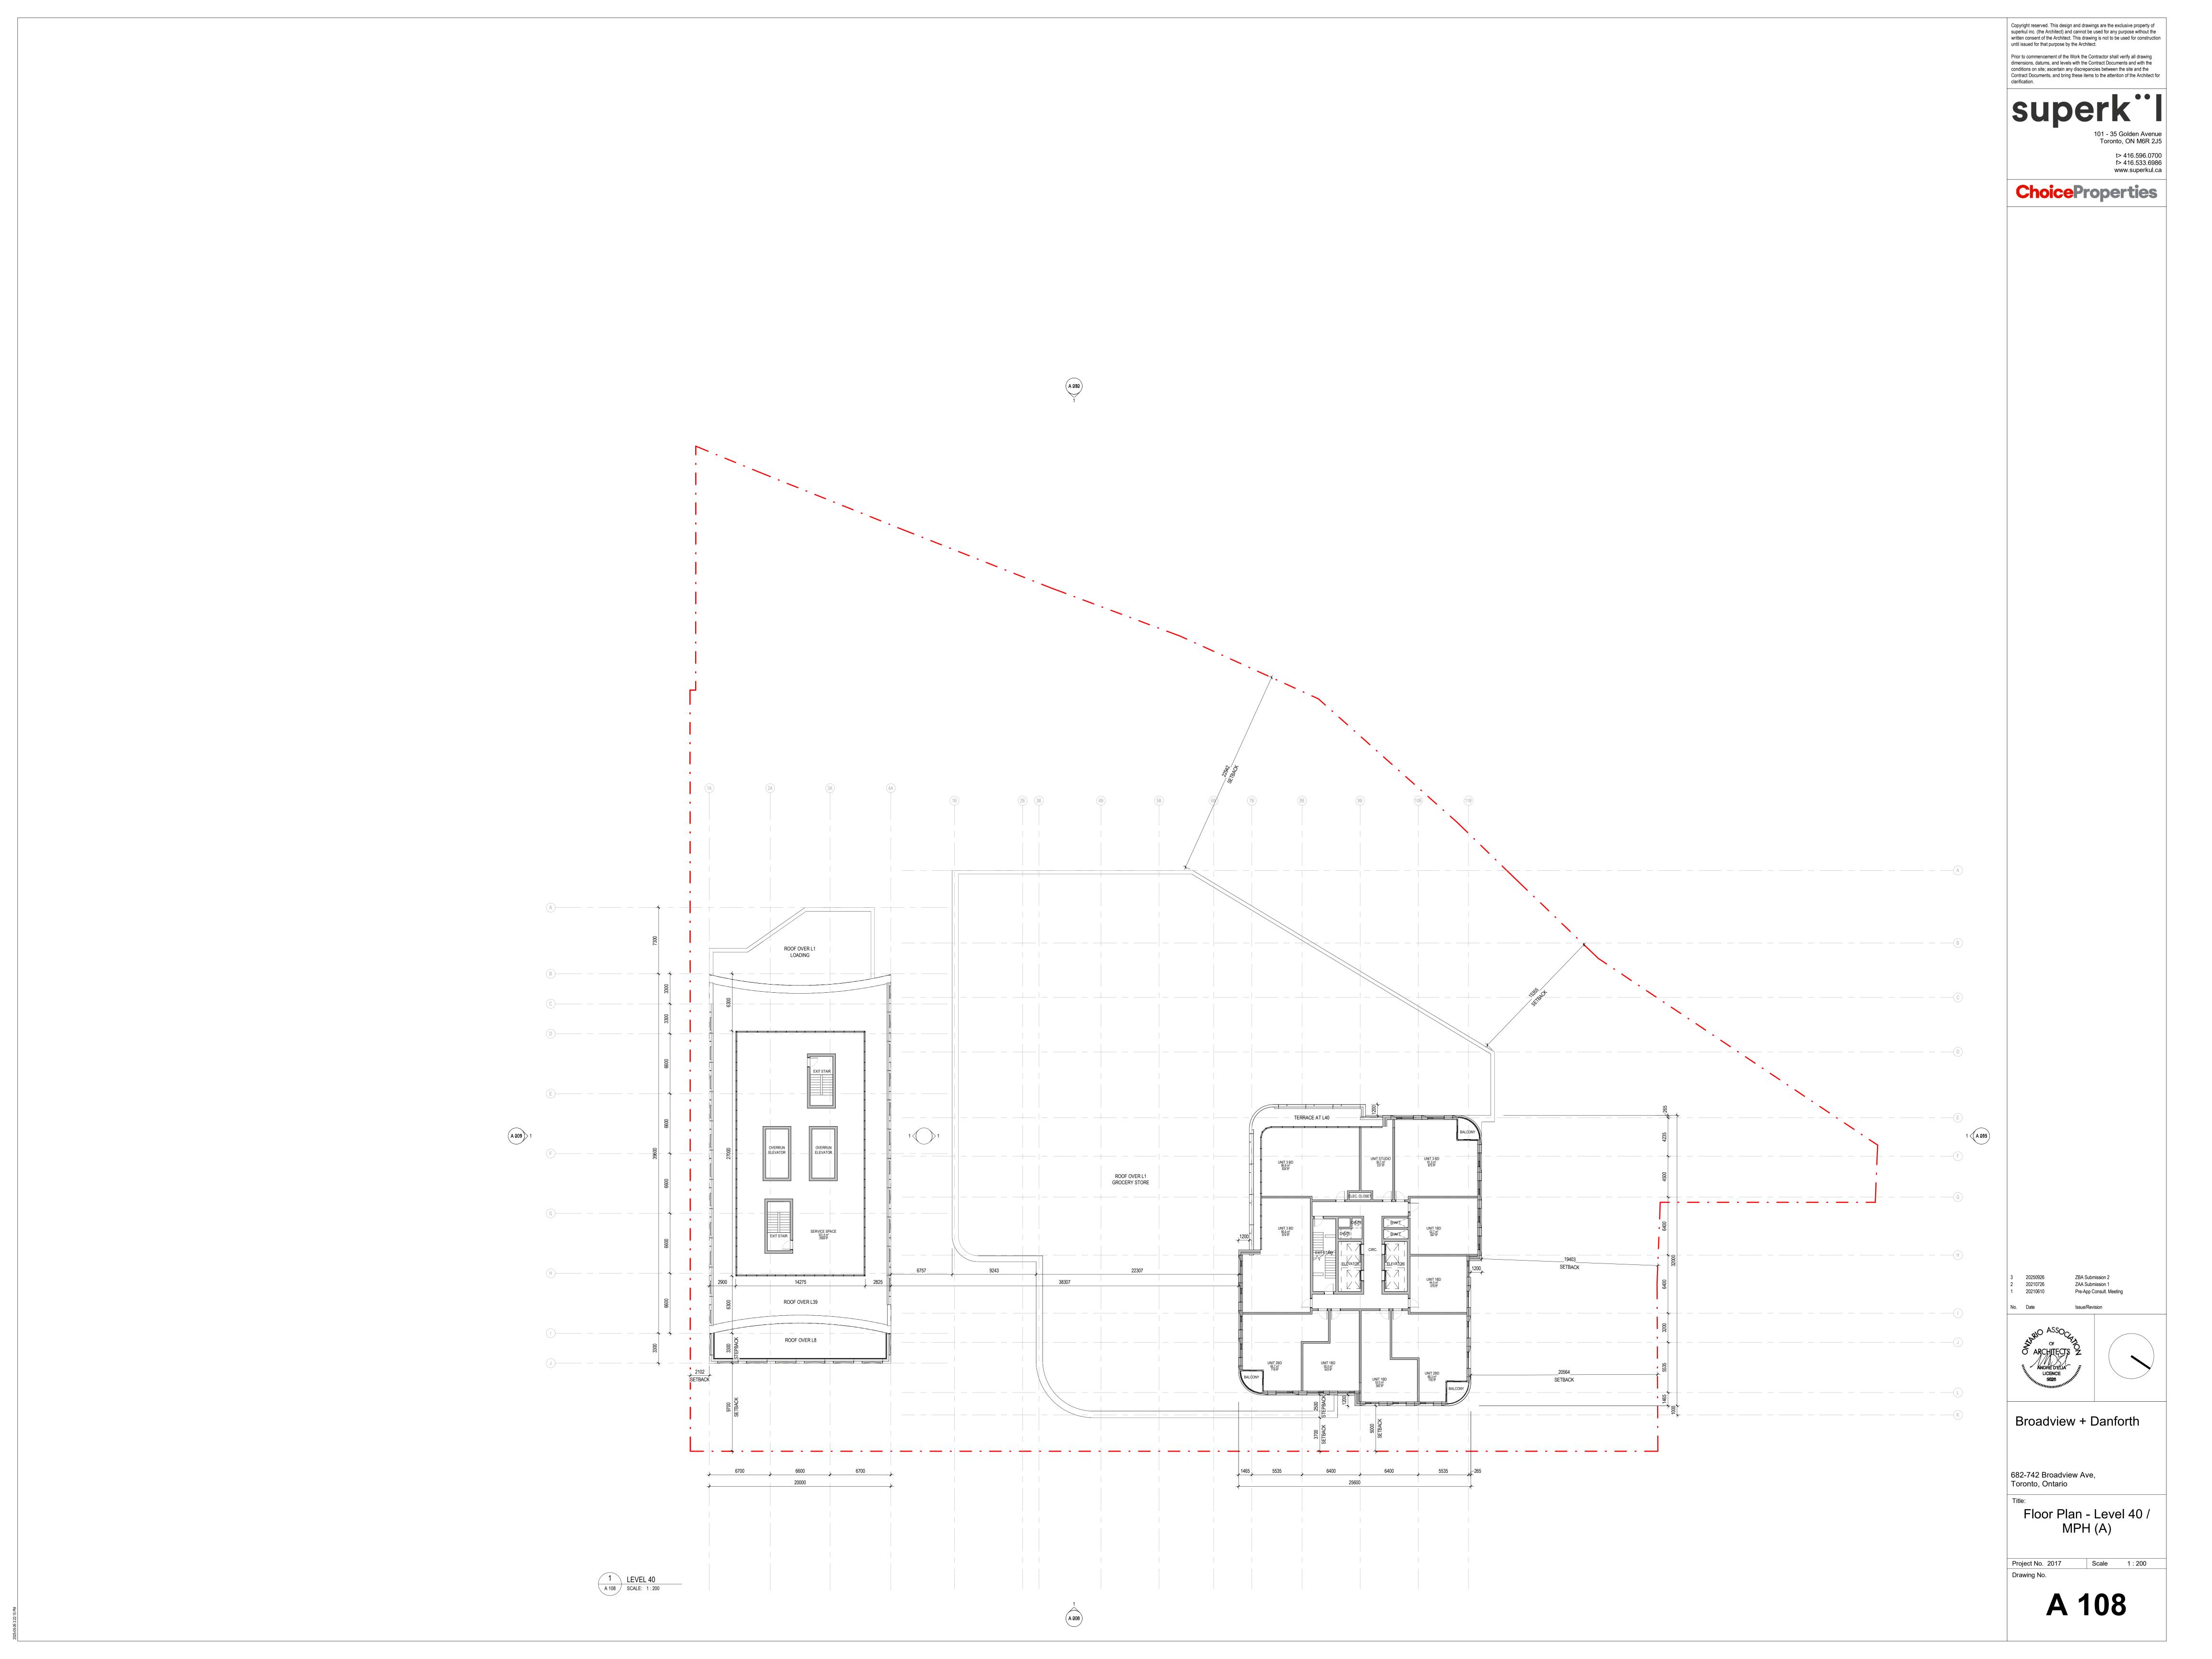

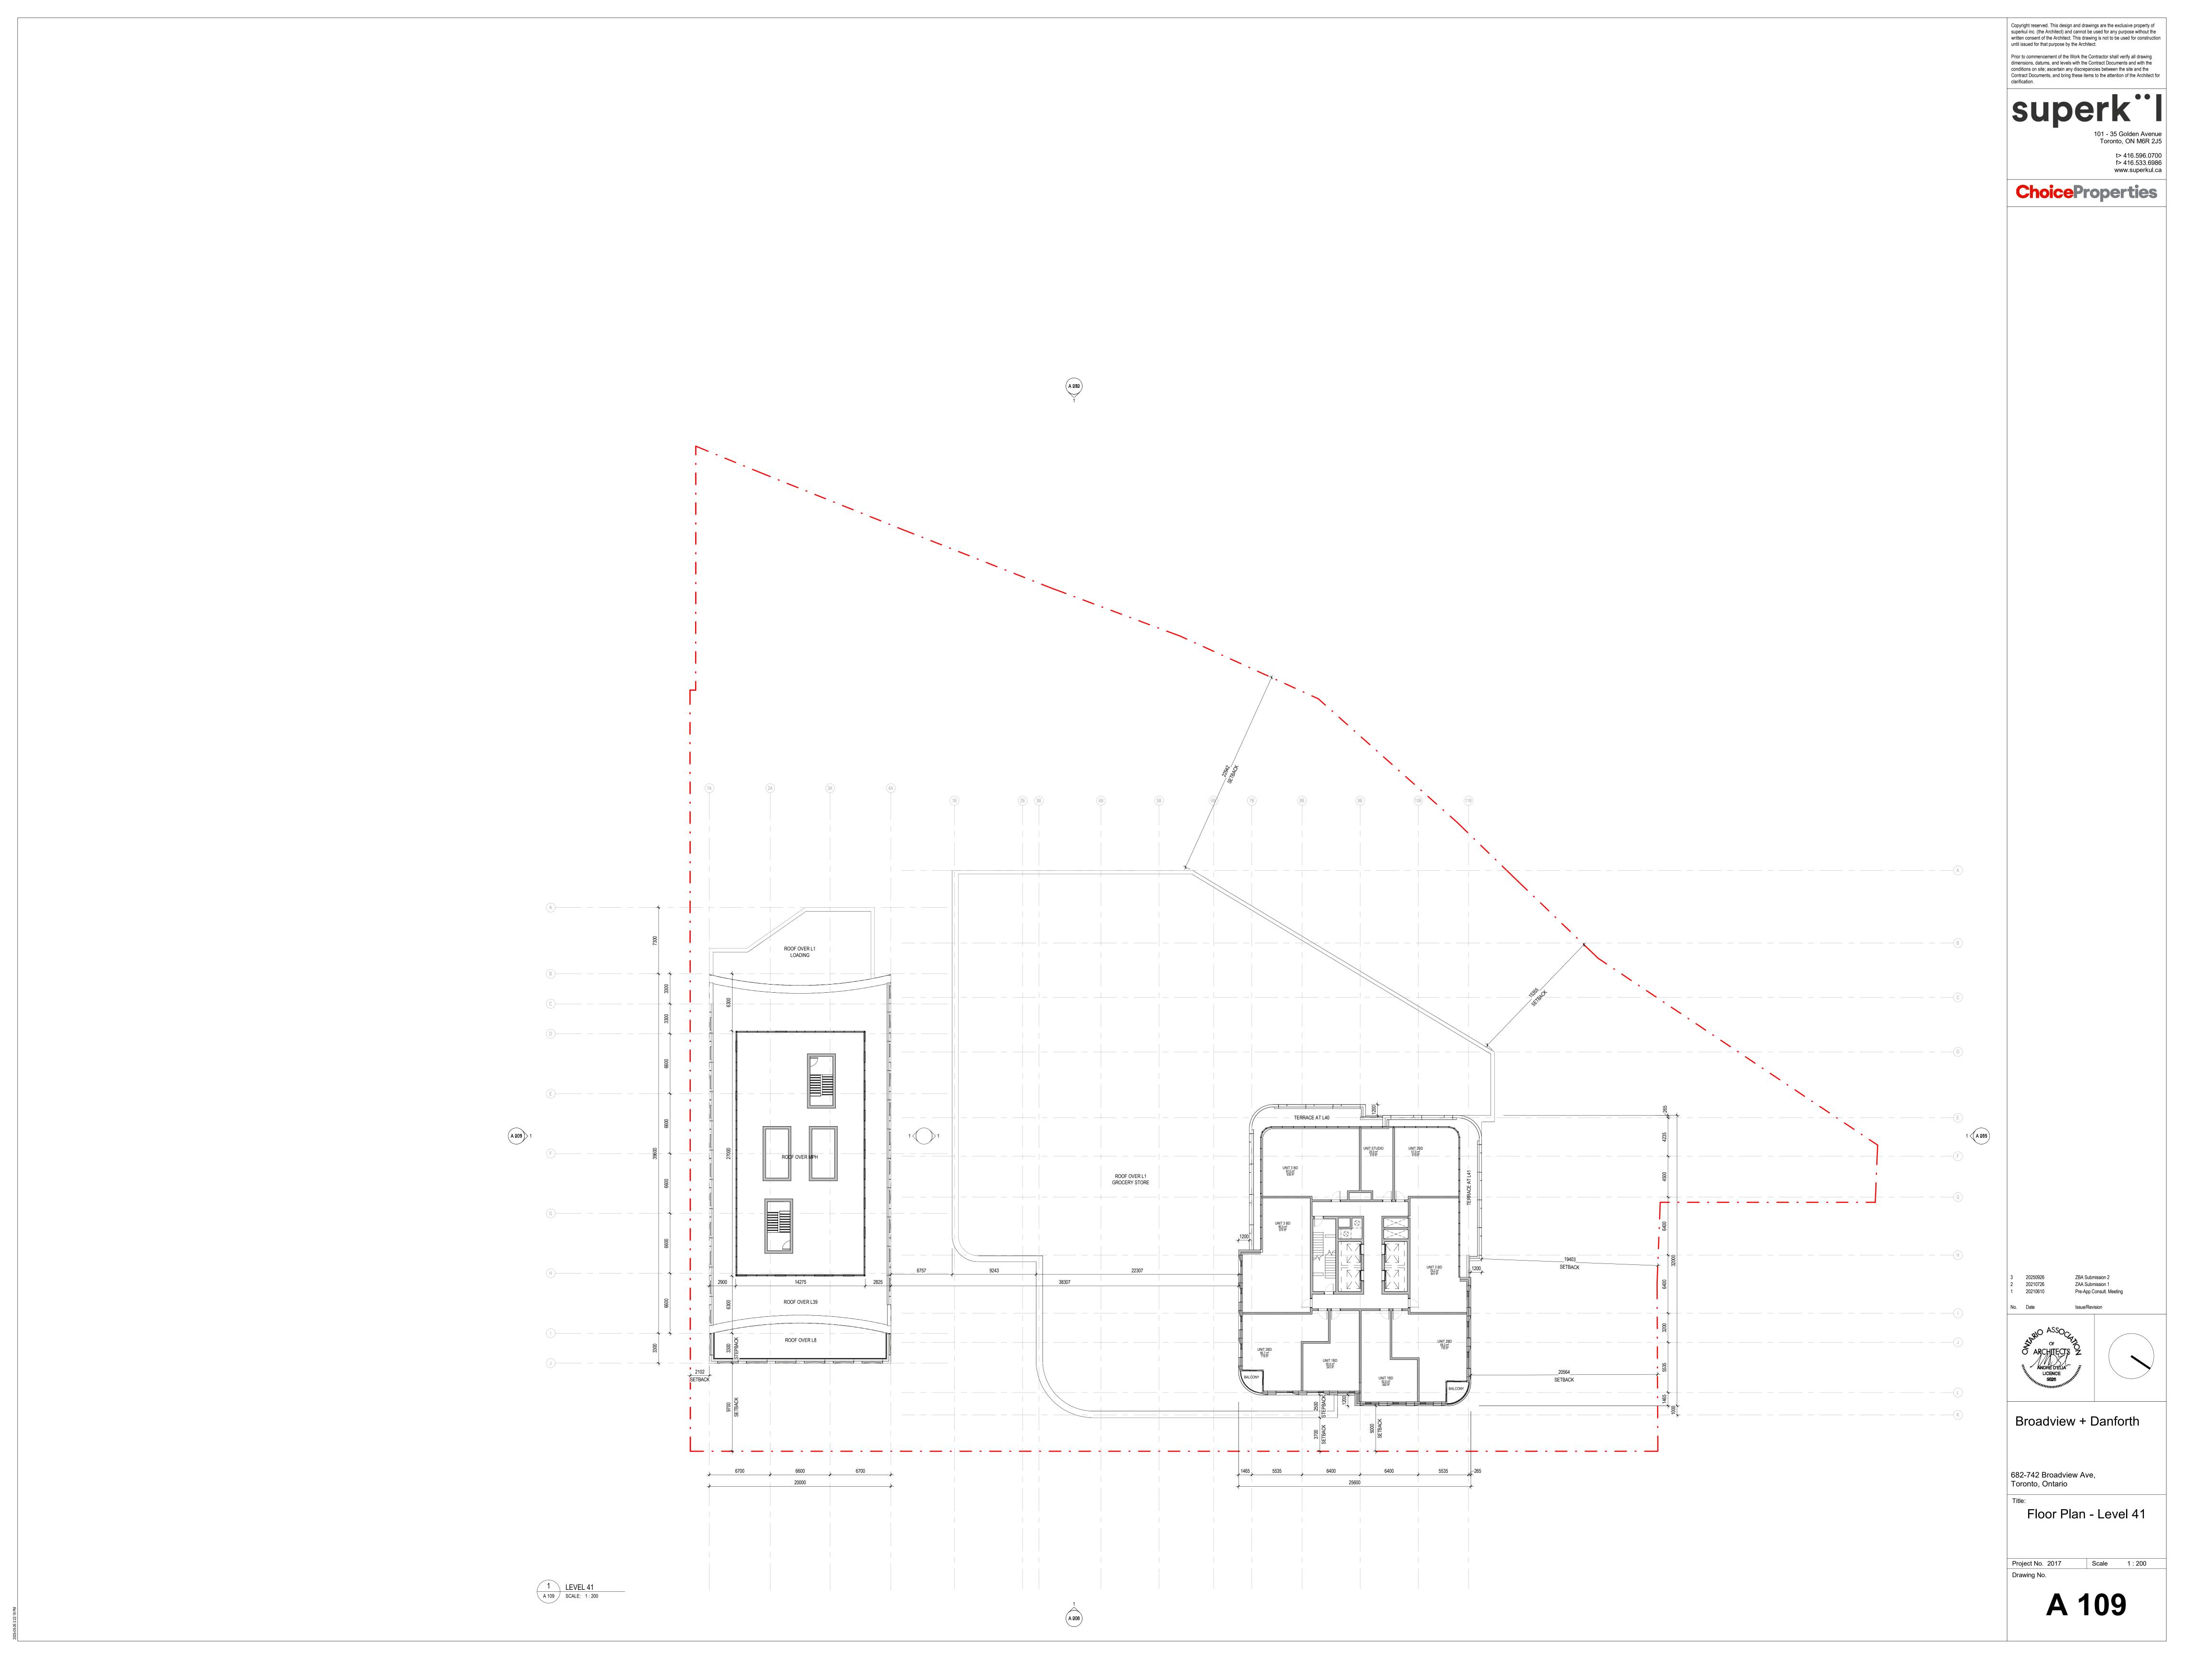

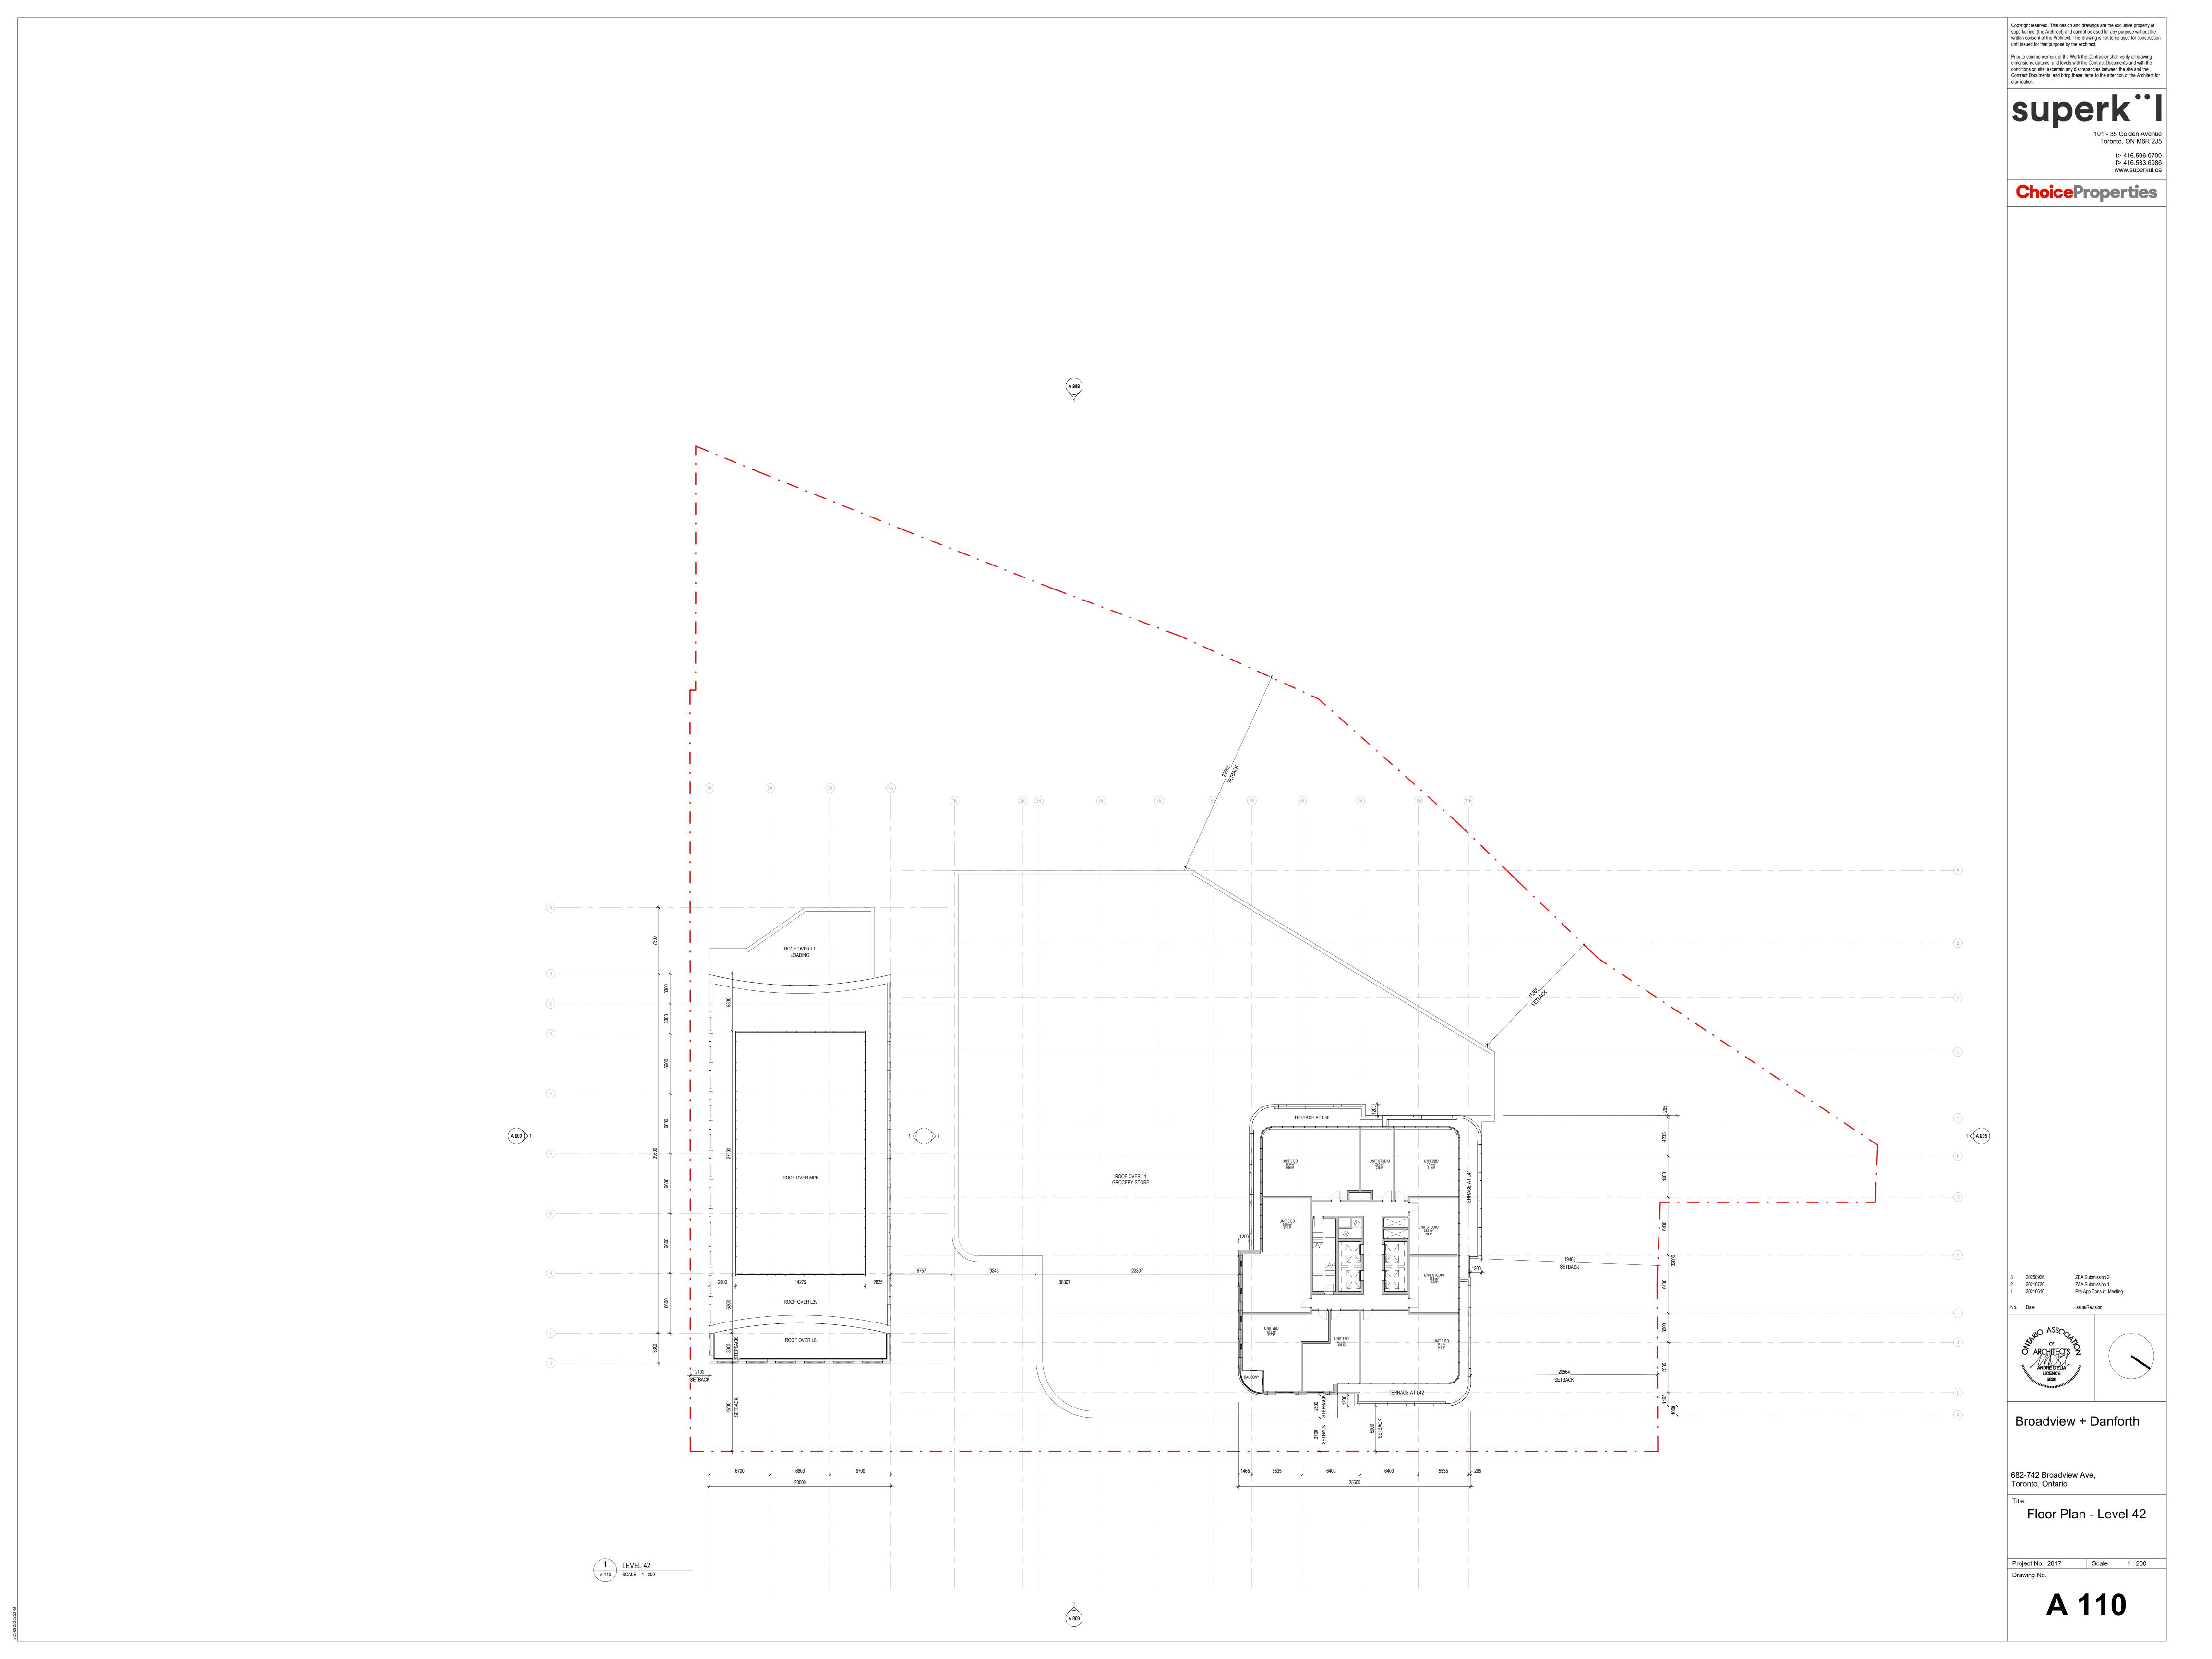

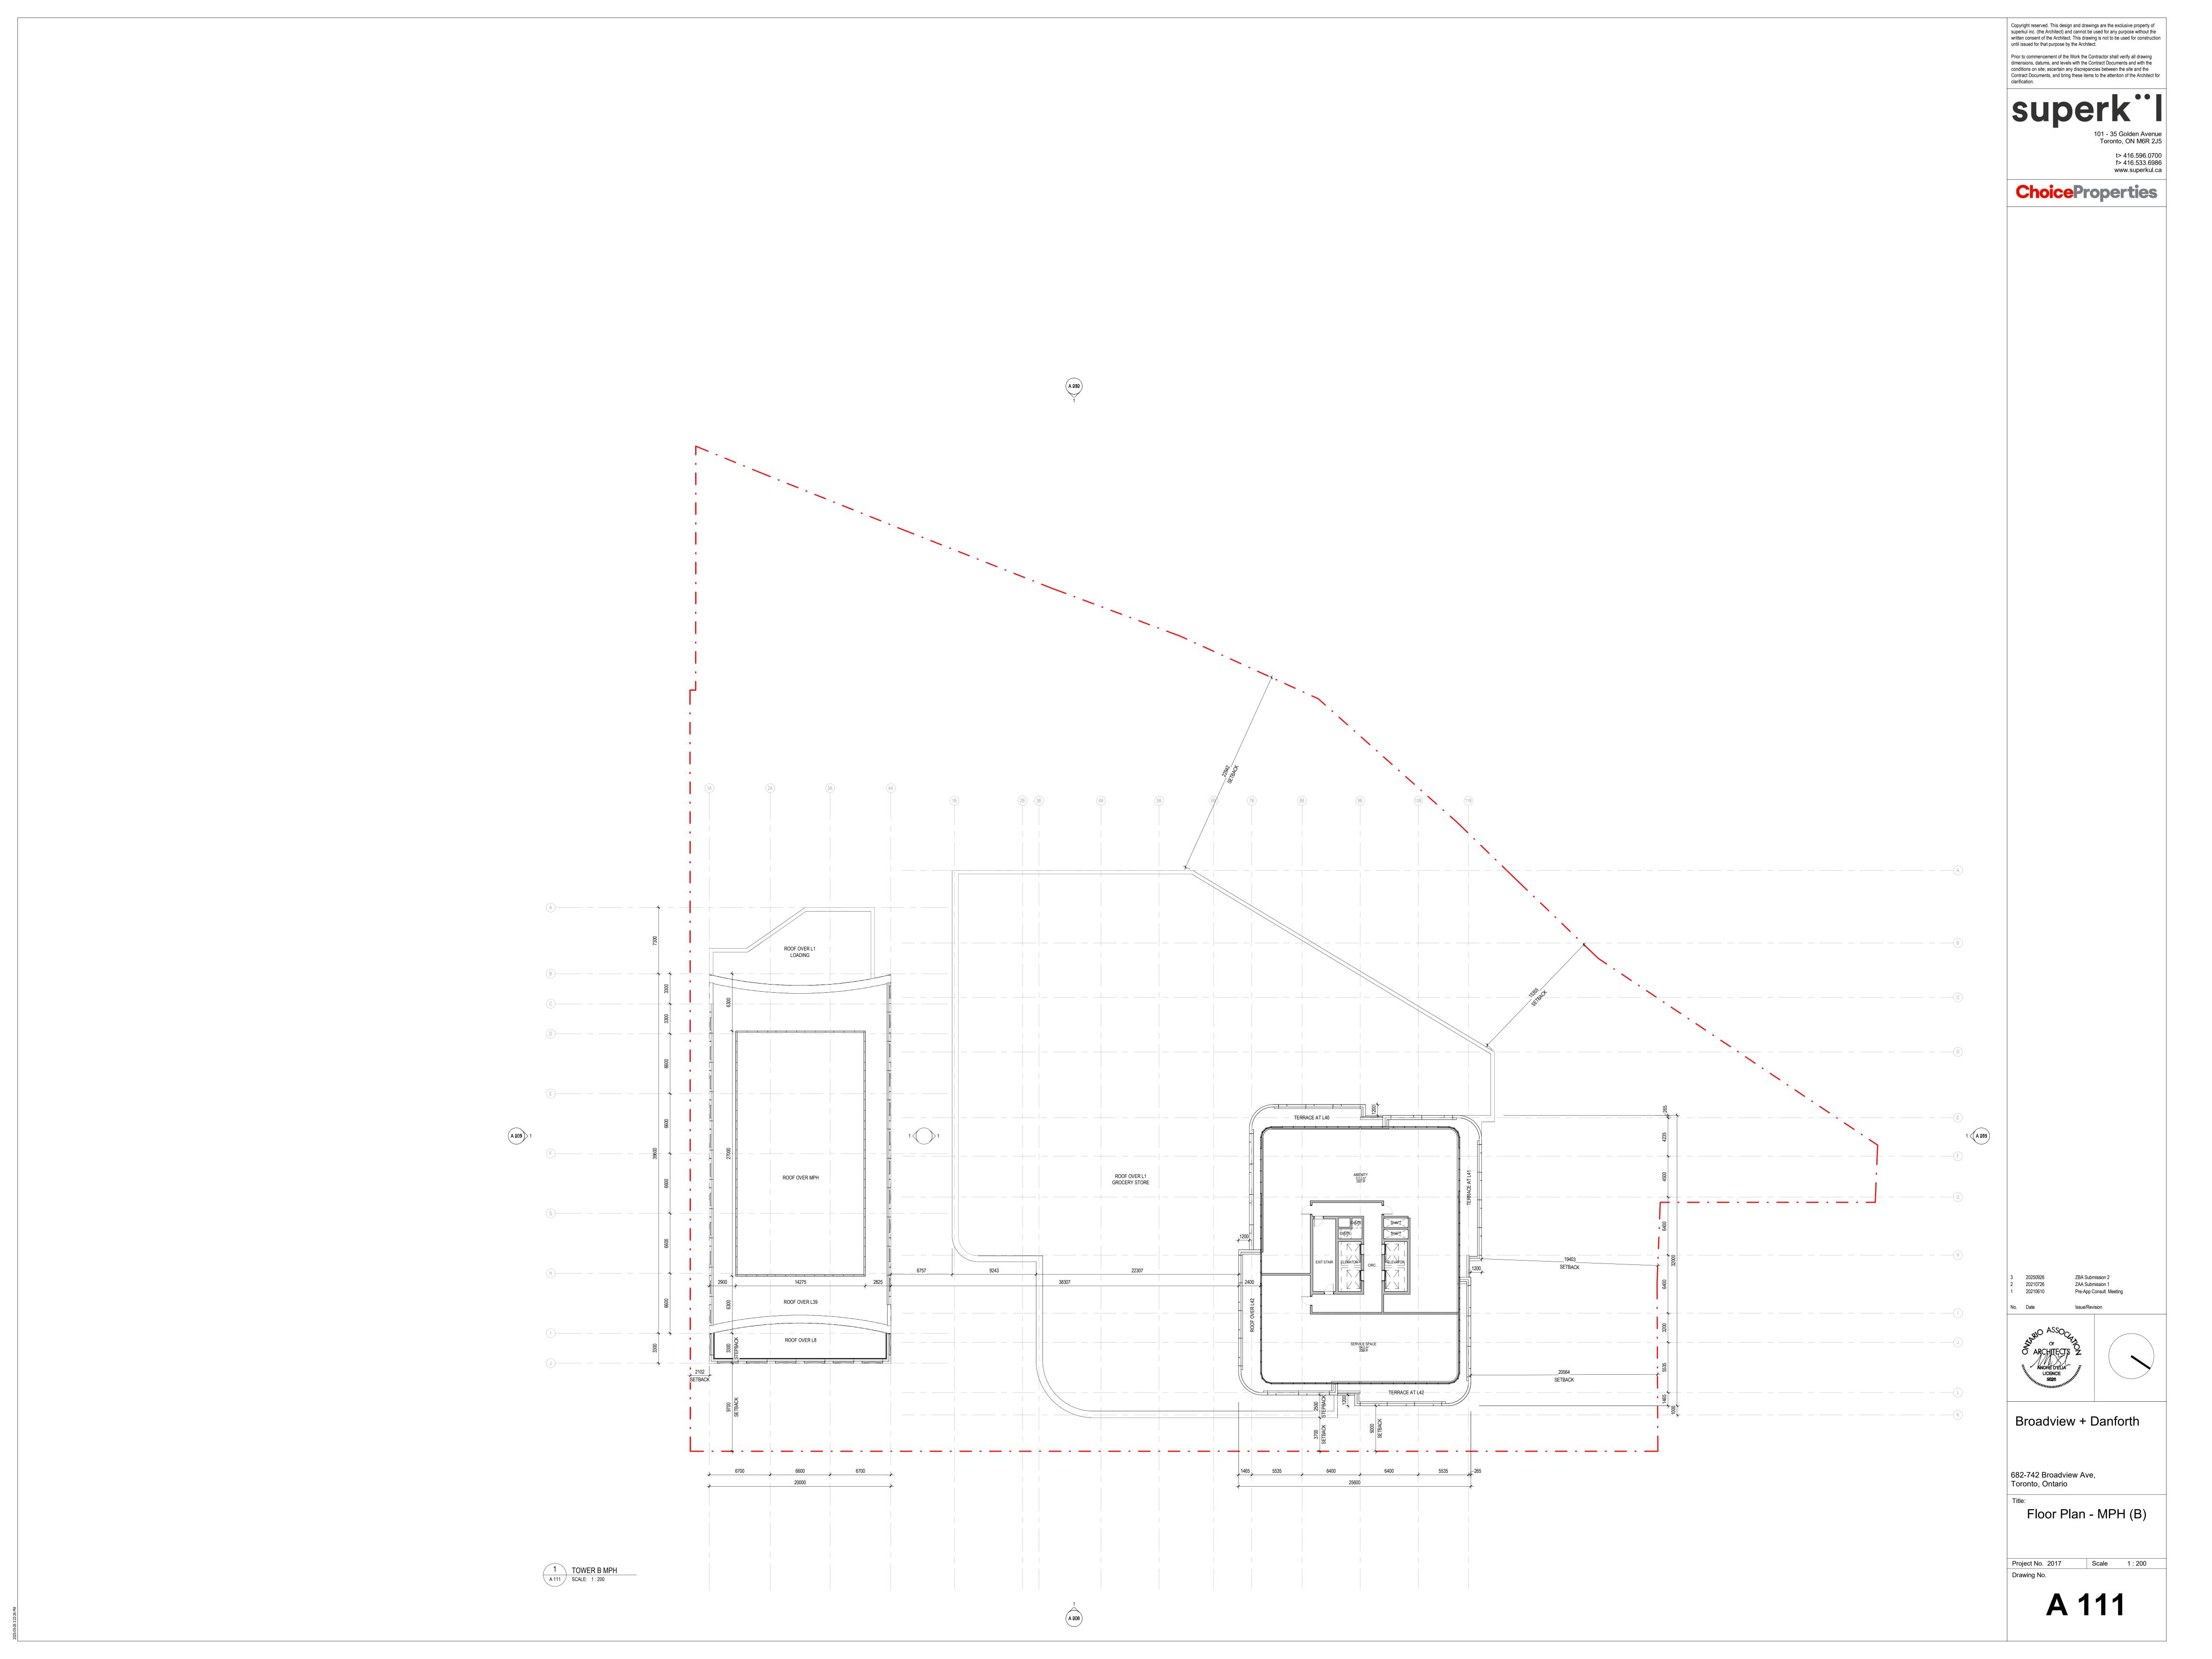

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ROOF LEGEND Area of Green Roof

Gross Floor Area, as defined in Green Roof Bylaw The total area of each floor level of a building, above and below average grade, measured from the exterior of the main wall of each floor level, including voids at the level of each floor, such as an atrium, mezzanine, stairwell, escalator, elevator, ventilation duct or utility shaft, but excluding areas used for the purpose of parking or loading

Provided

Required Provided 1,240.3 m² 1,294.2 m²

60%

33,702.1 m²

3,011.8 m²

GREEN ROOF STATISTICS BUILDING B

Area of Residential Private Terraces (m²)

Area of Renewable Energy Devices (m2)

Gross Floor Area, as defined in Green Roof Bylaw (m²)

Tower(s) Roof Area with floor plate less than 750m²

Rooftop Outdoor Amenity Space, if in a Residential Building (m²)

Green Roof

Total Roof Area (m²)

Green Roof Coverage

Total Available Roof Space (m²)

Coverage of Available Roof Space (m²)

Coverage of Available Roof Space (%)

Provided

Required Provided 474.8 m² 478.6 m²

60%

30,079.6 m² 957.5 m²

166.1 m²

GREEN ROOF STATISTICS BUILDING A

Area of Residential Private Terraces (m²)

Area of Renewable Energy Devices (m2)

Total Roof Area (m²)

Total Available Roof Space (m²)

Green Roof Coverage
Coverage of Available Roof Space (m²)

Coverage of Available Roof Space (%)


Gross Floor Area, as defined in Green Roof Bylaw (m²)

Tower(s) Roof Area with floor plate less than 750m²

Rooftop Outdoor Amenity Space, if in a Residential Building (m²)


FLOOR PLATE AREA - The total area of a floor of a building, measured from the exterior of the main wall of the floor level, including voids at the level of the floor, such as an atrium, mezzanine, stairwell, escalator, elevator, ventilation duct or utility shaft.

> GROSS FLOOR AREA - The total area of each floor level of a building, above and below average grade, measured from the exterior of the main wall of each floor level, including voids at the level of each floor, such as an atrium, mezzanine, stairwell, escalator, elevator, ventilation duct or utility shaft, but excluding areas used for the purpose of

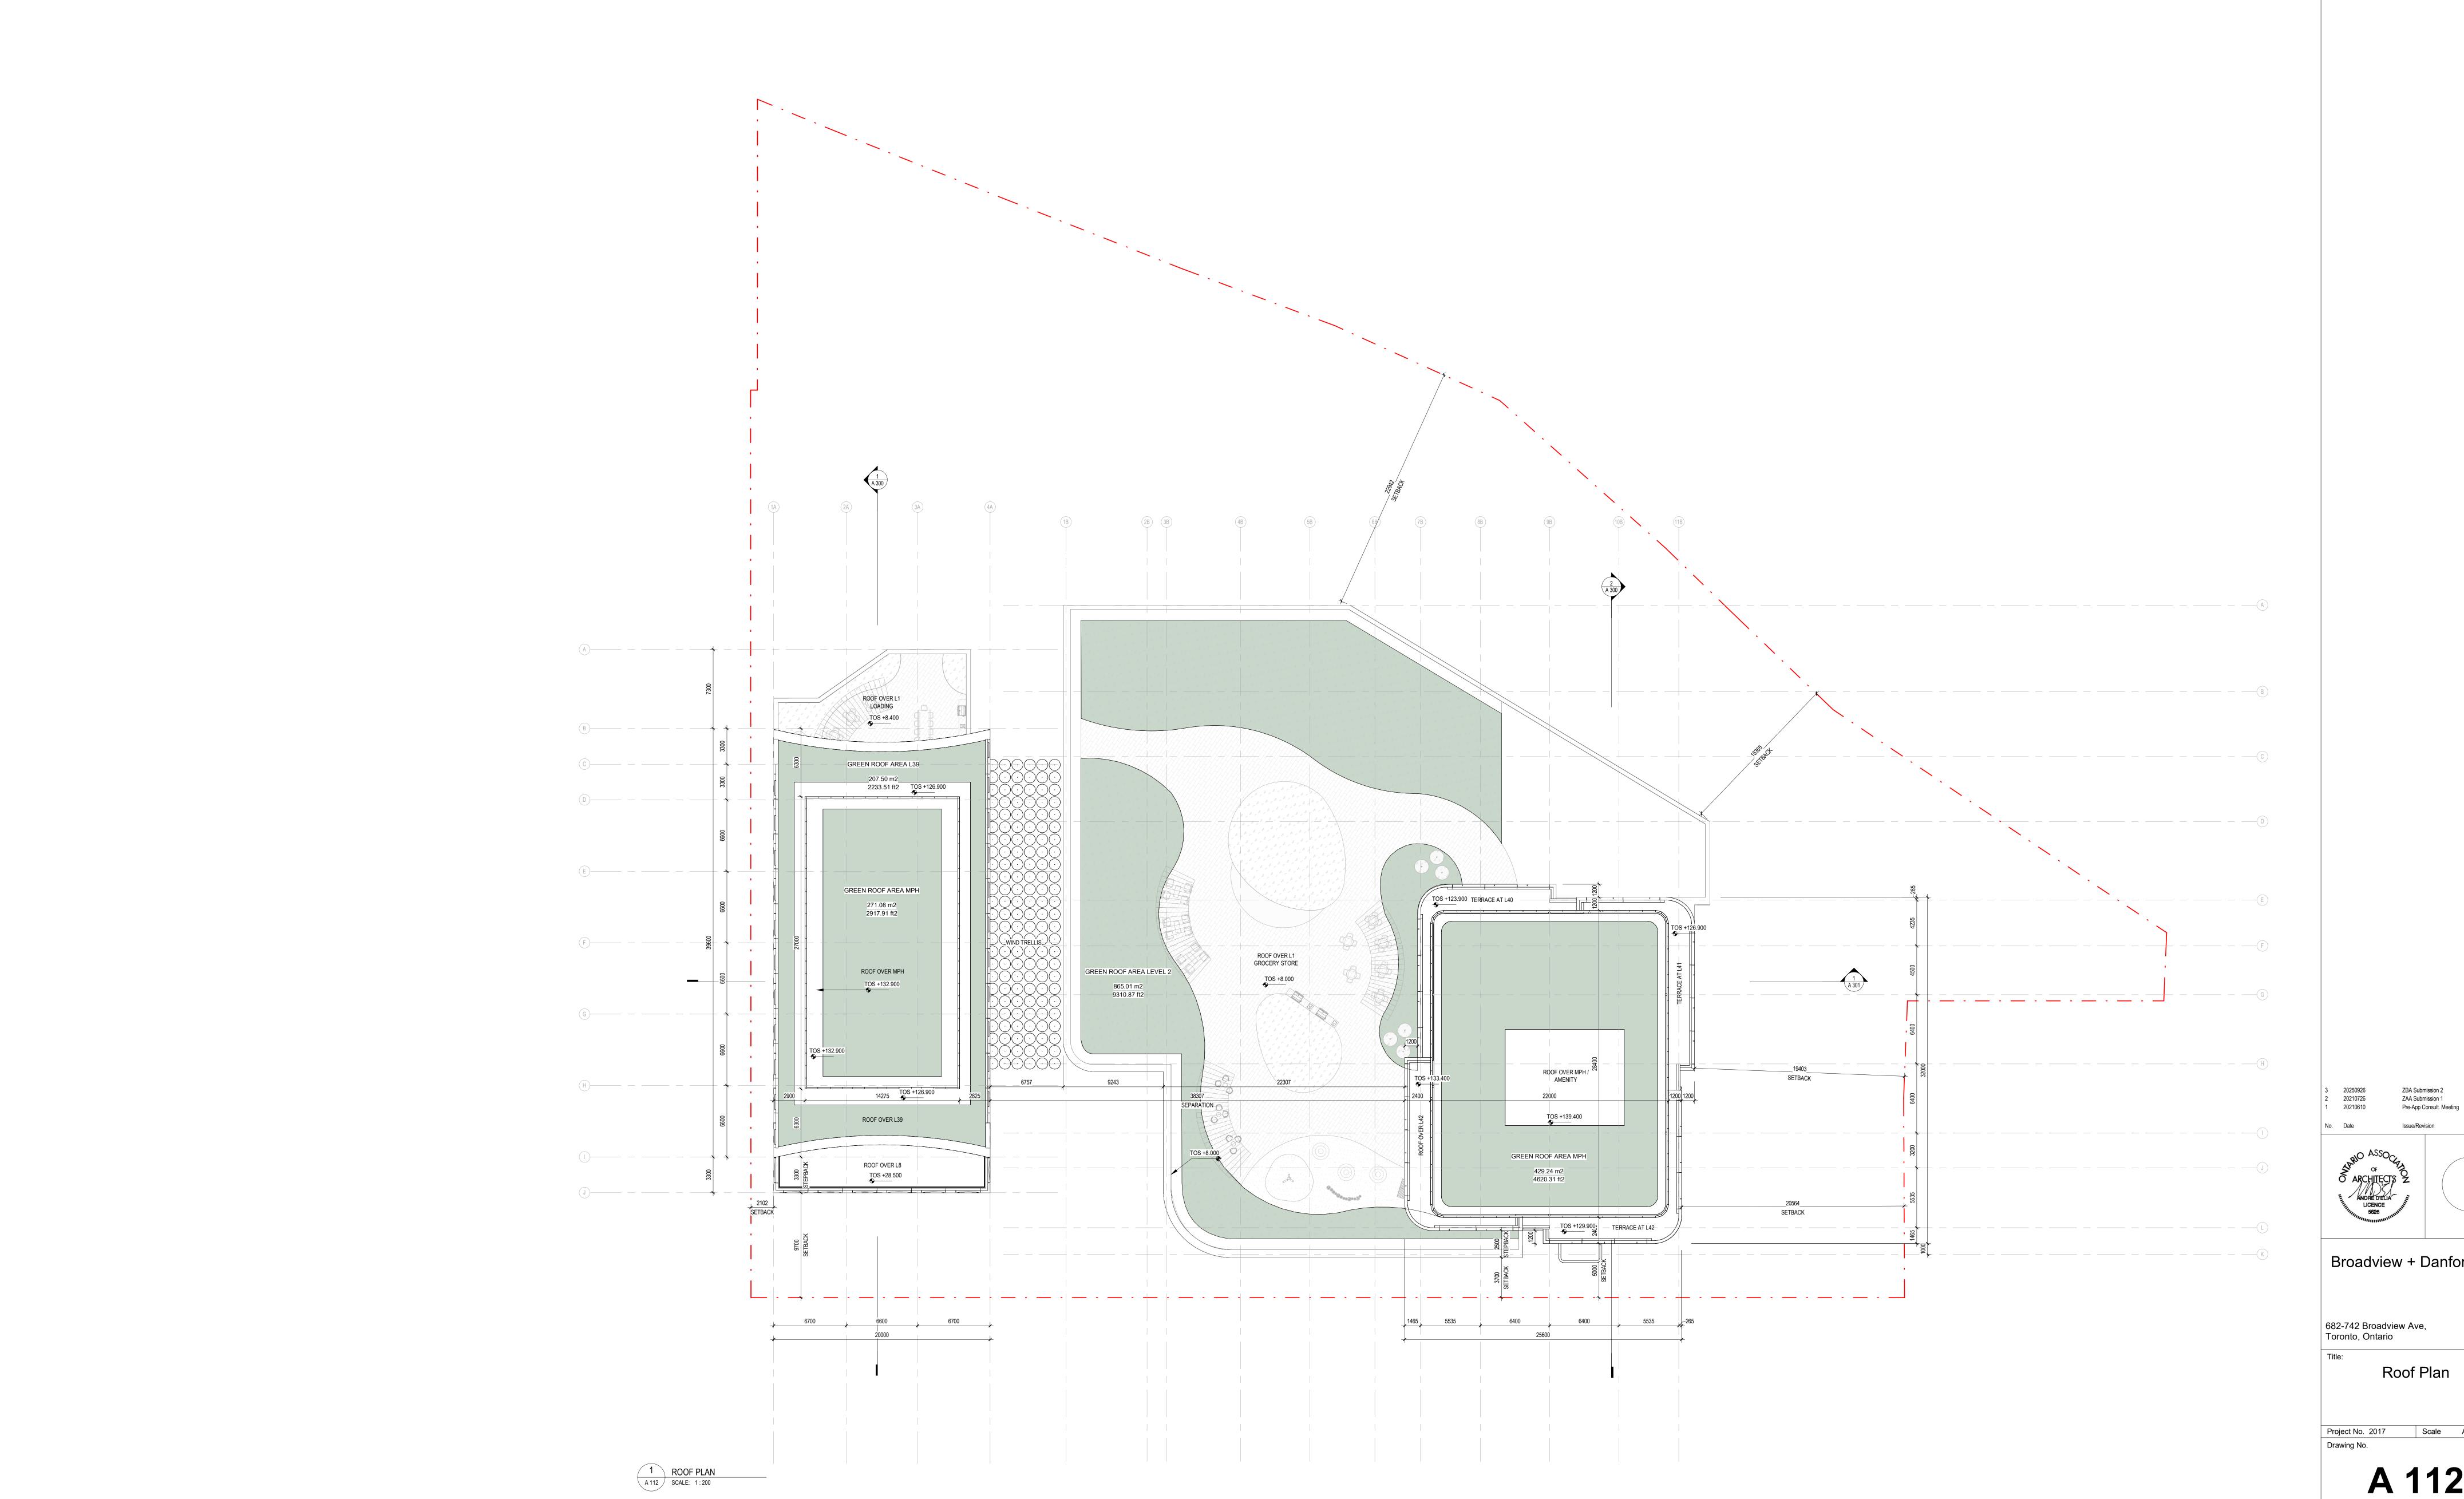

Roof Plan

Scale As indicated

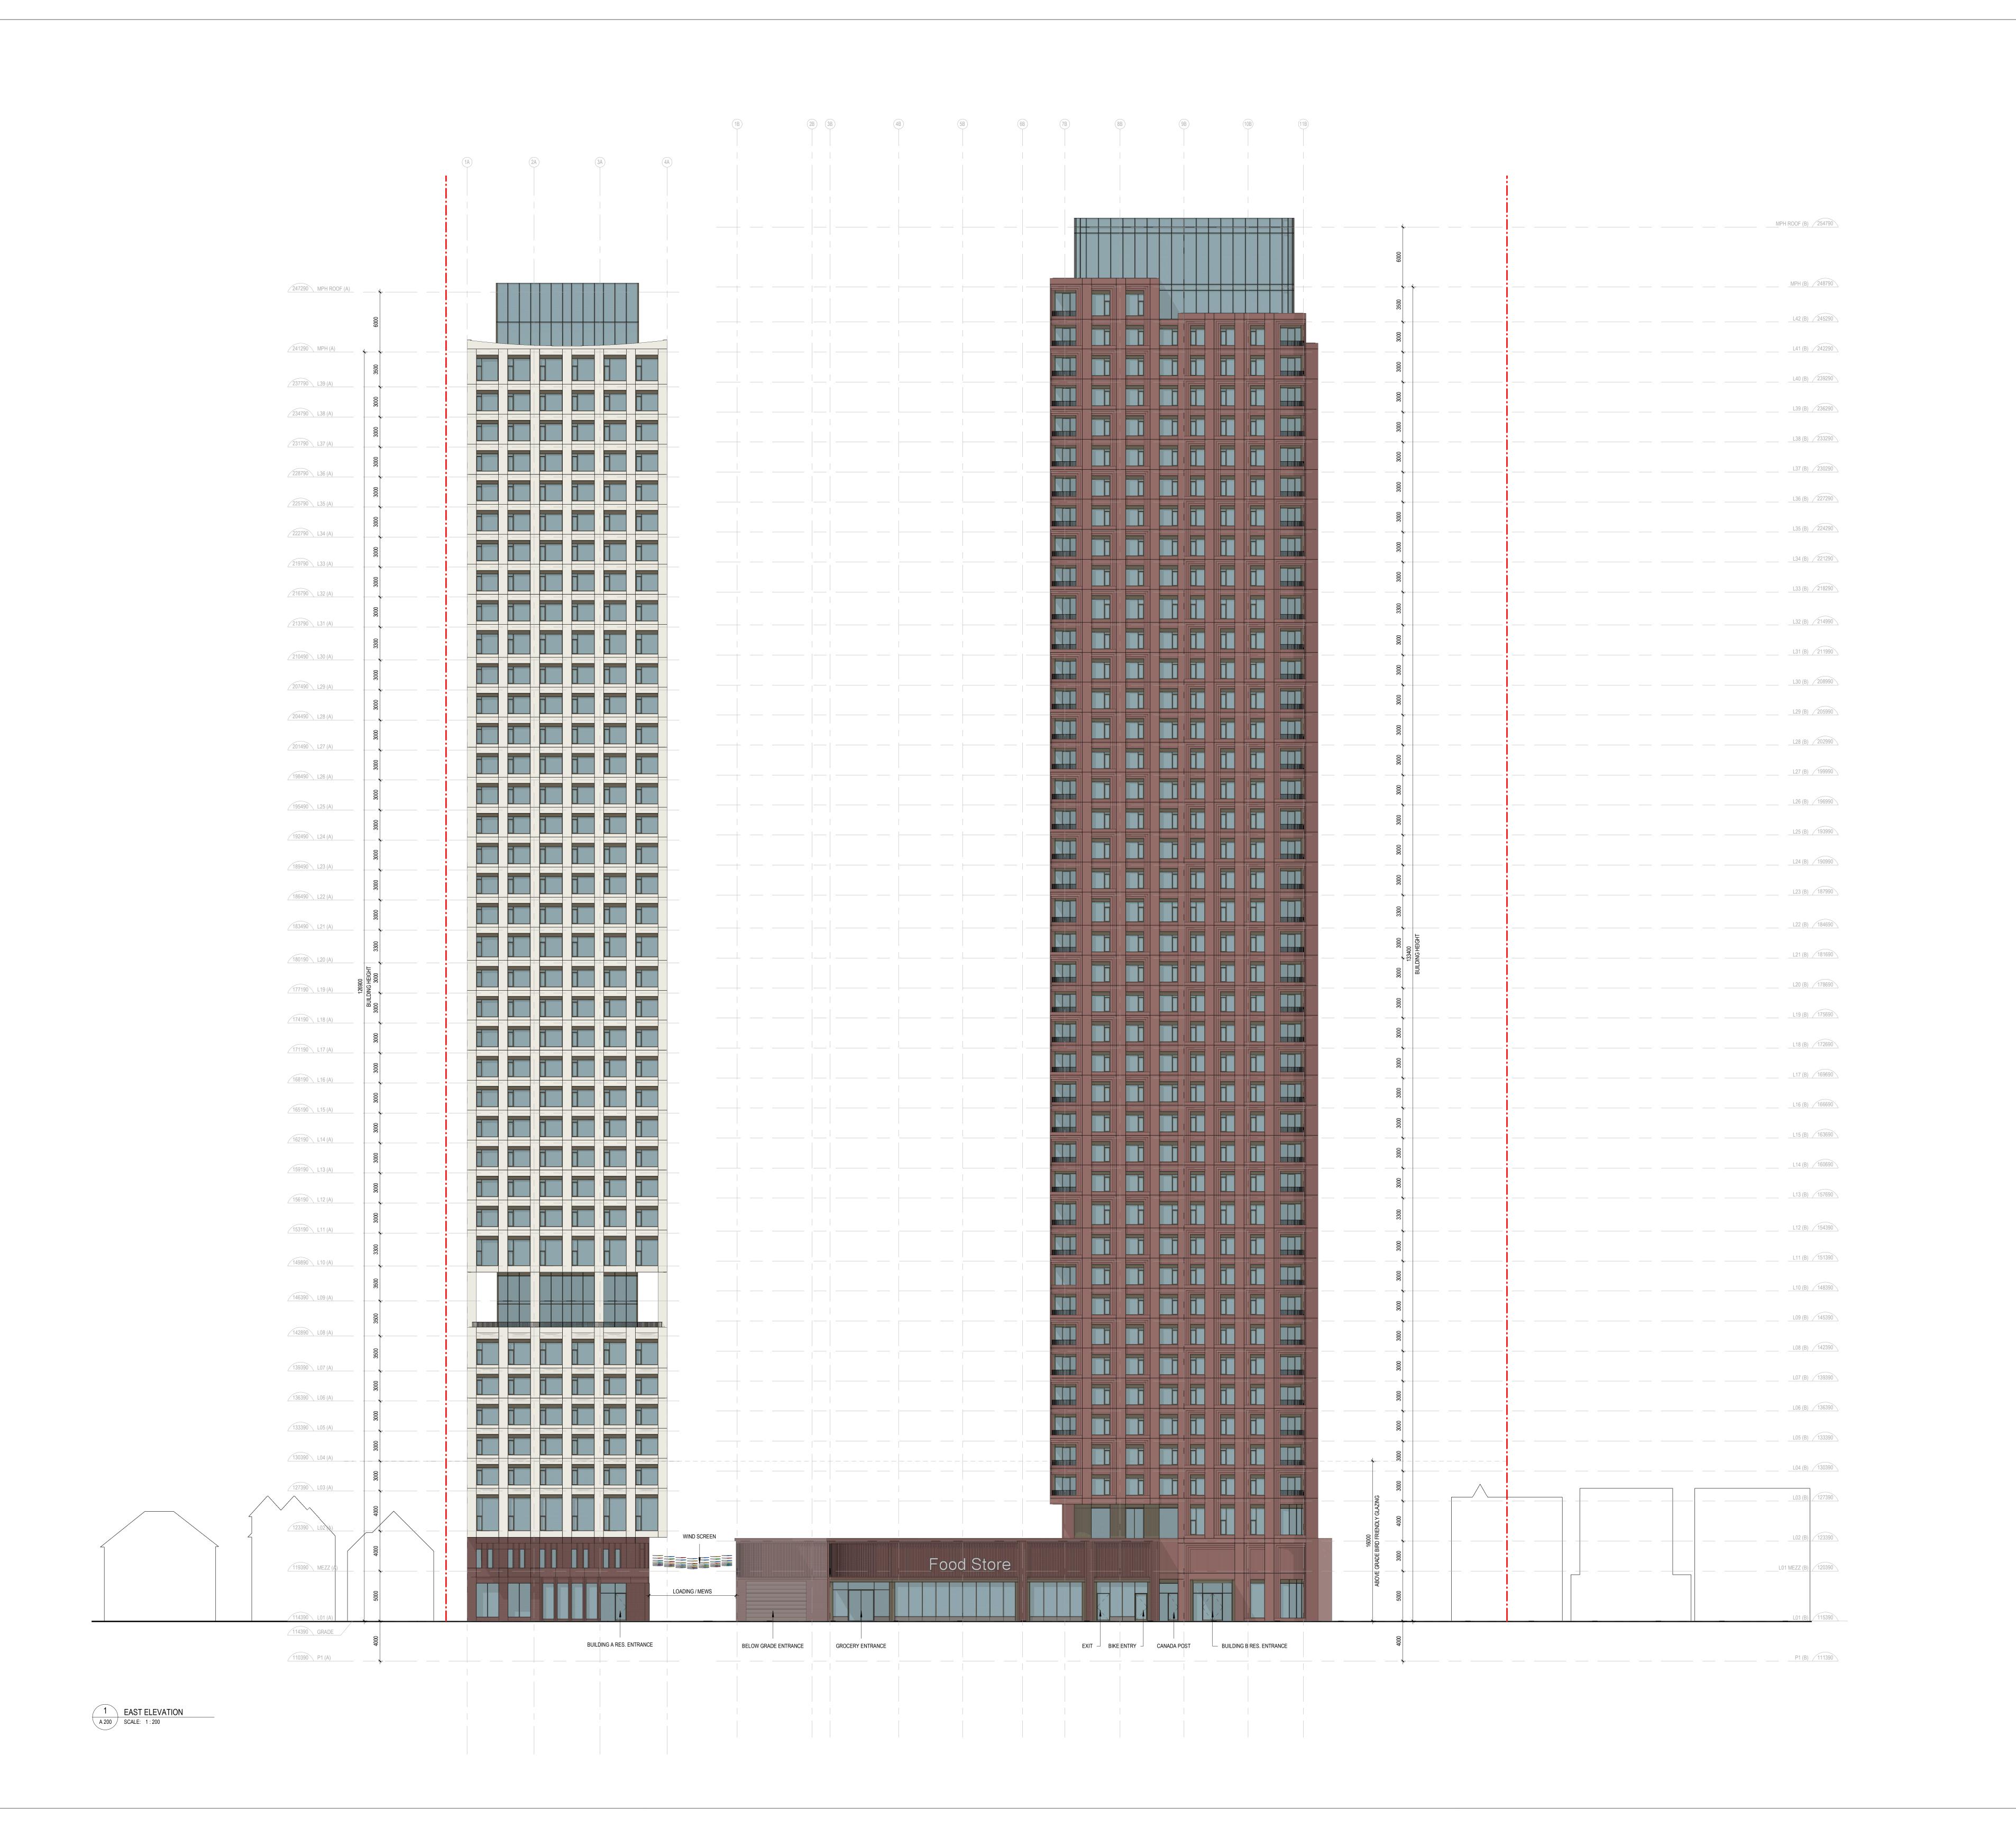

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MATERIAL LEGEND

PC-01 Precast Concrete, Beige
Typ.

PC-01a Precast Textured Concrete, Beige Typ.

PC-02 Precast Concrete, Red Typ.

Typ.

PC-02a Precast Textured Concrete, Red
Typ.

MAS-01 Masonry Type 1

MAS-01 Masonry Type 1
Typ. Red Brick

MAS-02 Masonry Type 2
Typ. Textured Red Brick

ST-01 Stone Base

MT-01 Metal Type 1
Bronze Aluminium

MT-02 Metal Louver Type 1
Bronze Aluminium

GL-01 Vision and Spandrel G

GL-01 Vision and Spandrel Glass
Typ.

GL-02 Bird friendly Vision and Spandrel Glass
Typ.

3 20250926 ZBA Submission 2 2 20210726 ZAA Submission 1 1 20210610 Pre-App Consult. Meeting




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Building Elevations

Project No. 2017 Scale As indicated

Drawing No.



conditions on site; ascertain any discrepancies between the site and the Contract Documents, and bring these items to the attention of the Architect for clarification.
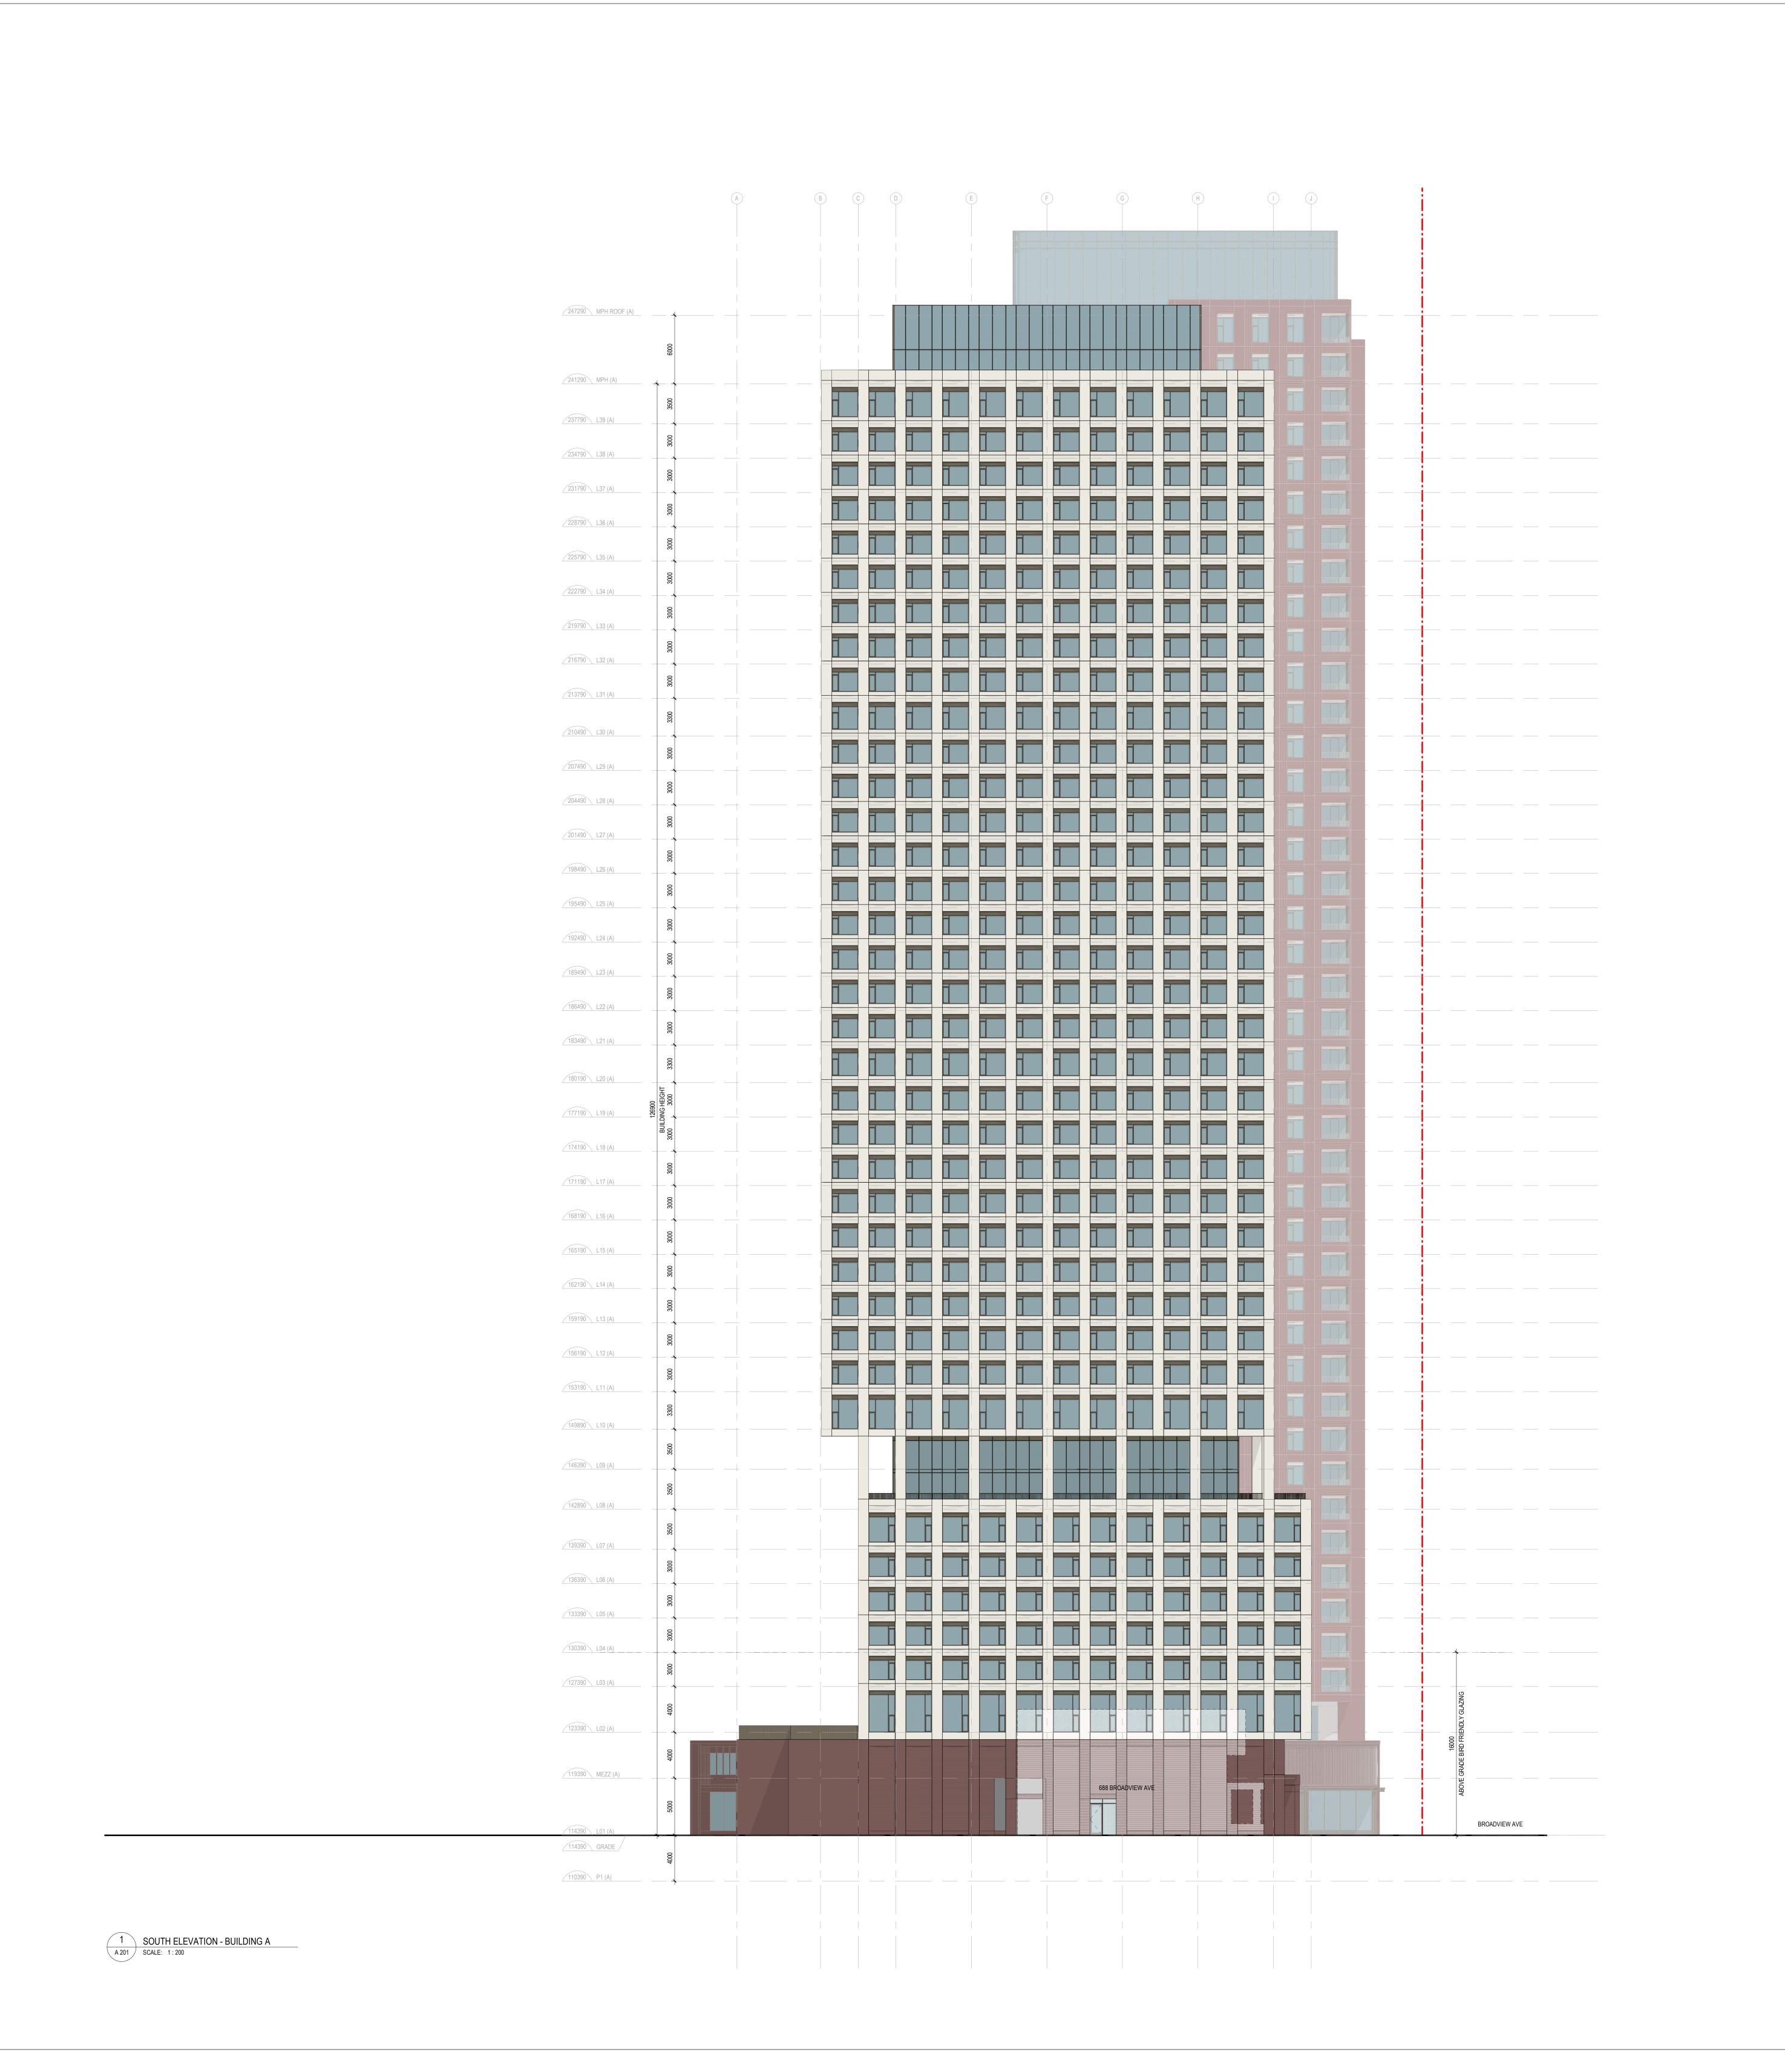
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ChoiceProperties

MATERIAL LEGEND

PC-01 Precast Concrete, Beige
Typ.

PC-01a Precast Textured Concrete, Beige Typ.

PC-02 Precast Concrete, Red Typ.

PC-02a Precast Textured Concrete, Red
Typ.

MAS-01 Masonry Type 1
Typ. Red Brick

MAS-02 Masonry Type 2
Typ. Textured Red Brick

ST-01 Stone Base
Grey

MT-01 Metal Type 1
Bronze Aluminium

MT-02 Metal Louver Type 1
Bronze Aluminium

GL-01 Vision and Spandrel Glass
Typ.

GL-02 Bird friendly Vision and Spandrel Glass Typ.

3 20250926 ZBA Submission 2 2 20210726 ZAA Submission 1 1 20210610 Pre-App Consult. Meeting

ARCHITECTS Z


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Building Elevations

Project No. 2017 Scale As indicated

Drawing No.



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MATERIAL LEGEND

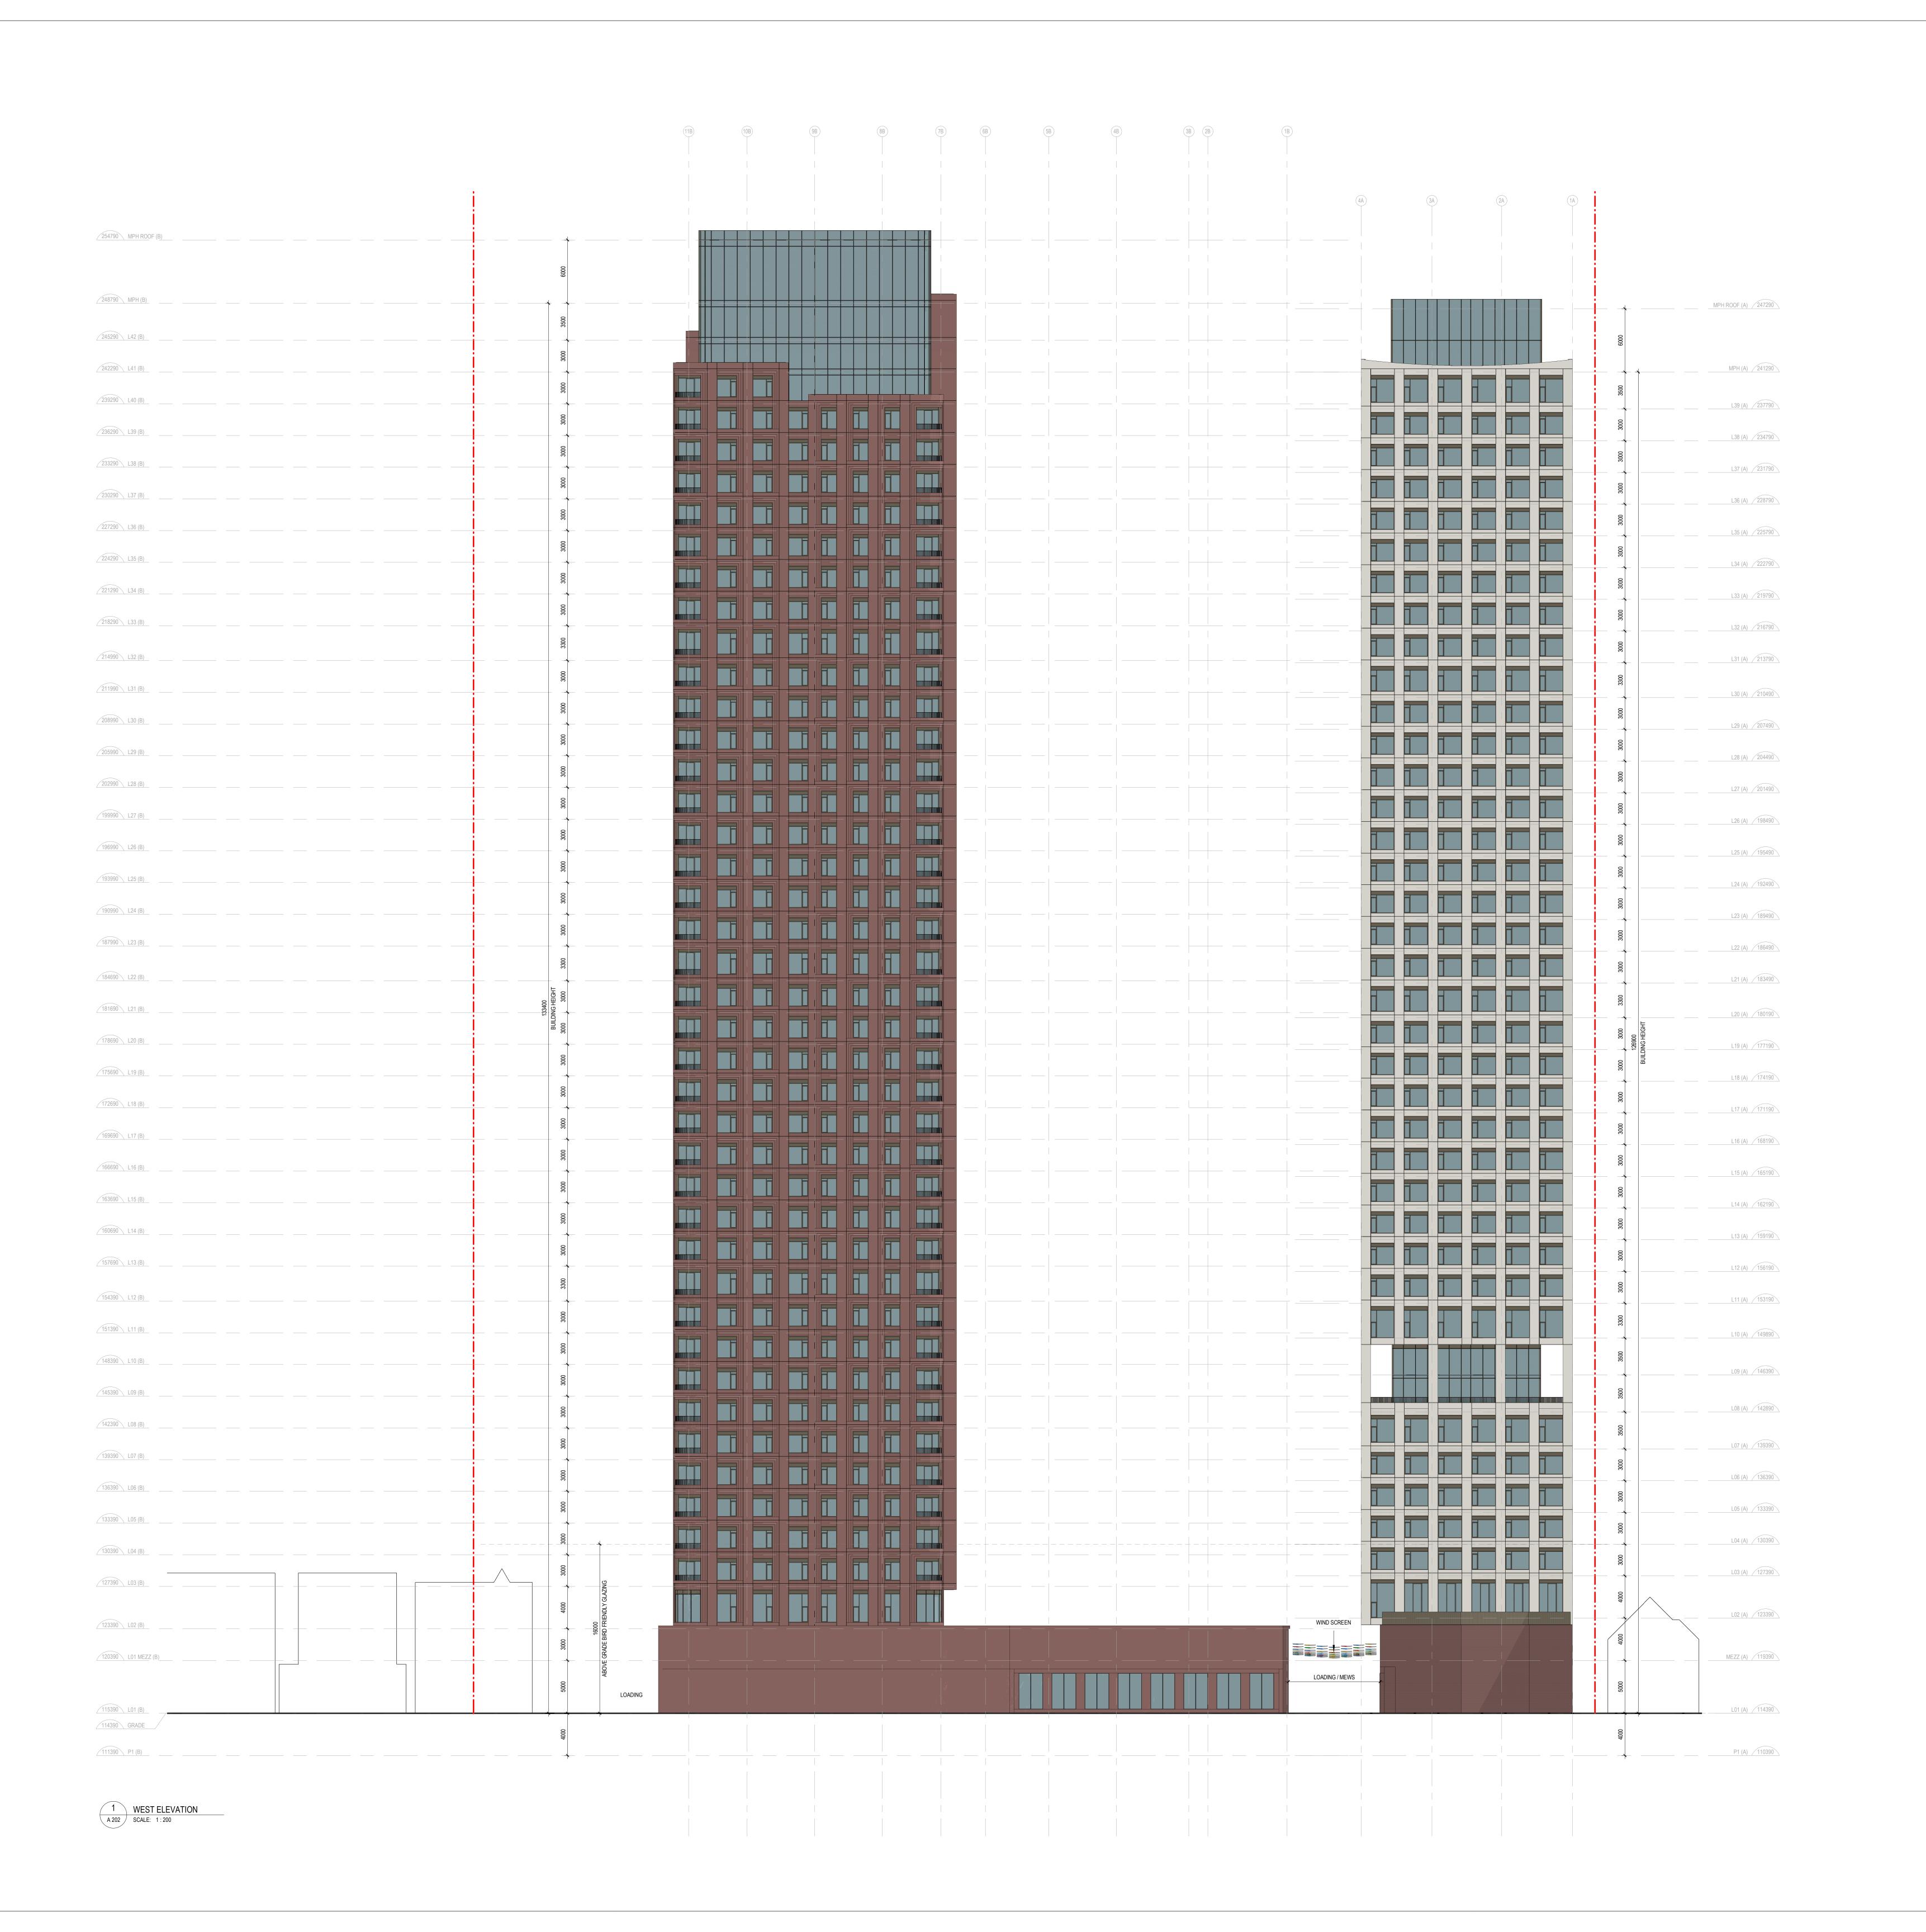PC-01 Precast Concrete, Beige
Typ.

PC-01a Precast Textured Concrete, Beige Typ.

PC-02 Precast Concrete, Red Typ.

PC-02a Precast Textured Concrete Red

PC-02a Precast Textured Concrete, Red
Typ.

MAS-01 Masonry Type 1
Typ. Red Brick

MAS-02 Masonry Type 2
Typ. Textured Red Brick

ST-01 Stone Base
Grey

MT-01 Metal Type 1
Bronze Aluminium

MT-02 Metal Louver Type 1
Bronze Aluminium

GL-01 Vision and Spandrel Glass
Typ.

Typ.

GL-02 Bird friendly Vision and Spandrel Glass
Typ.

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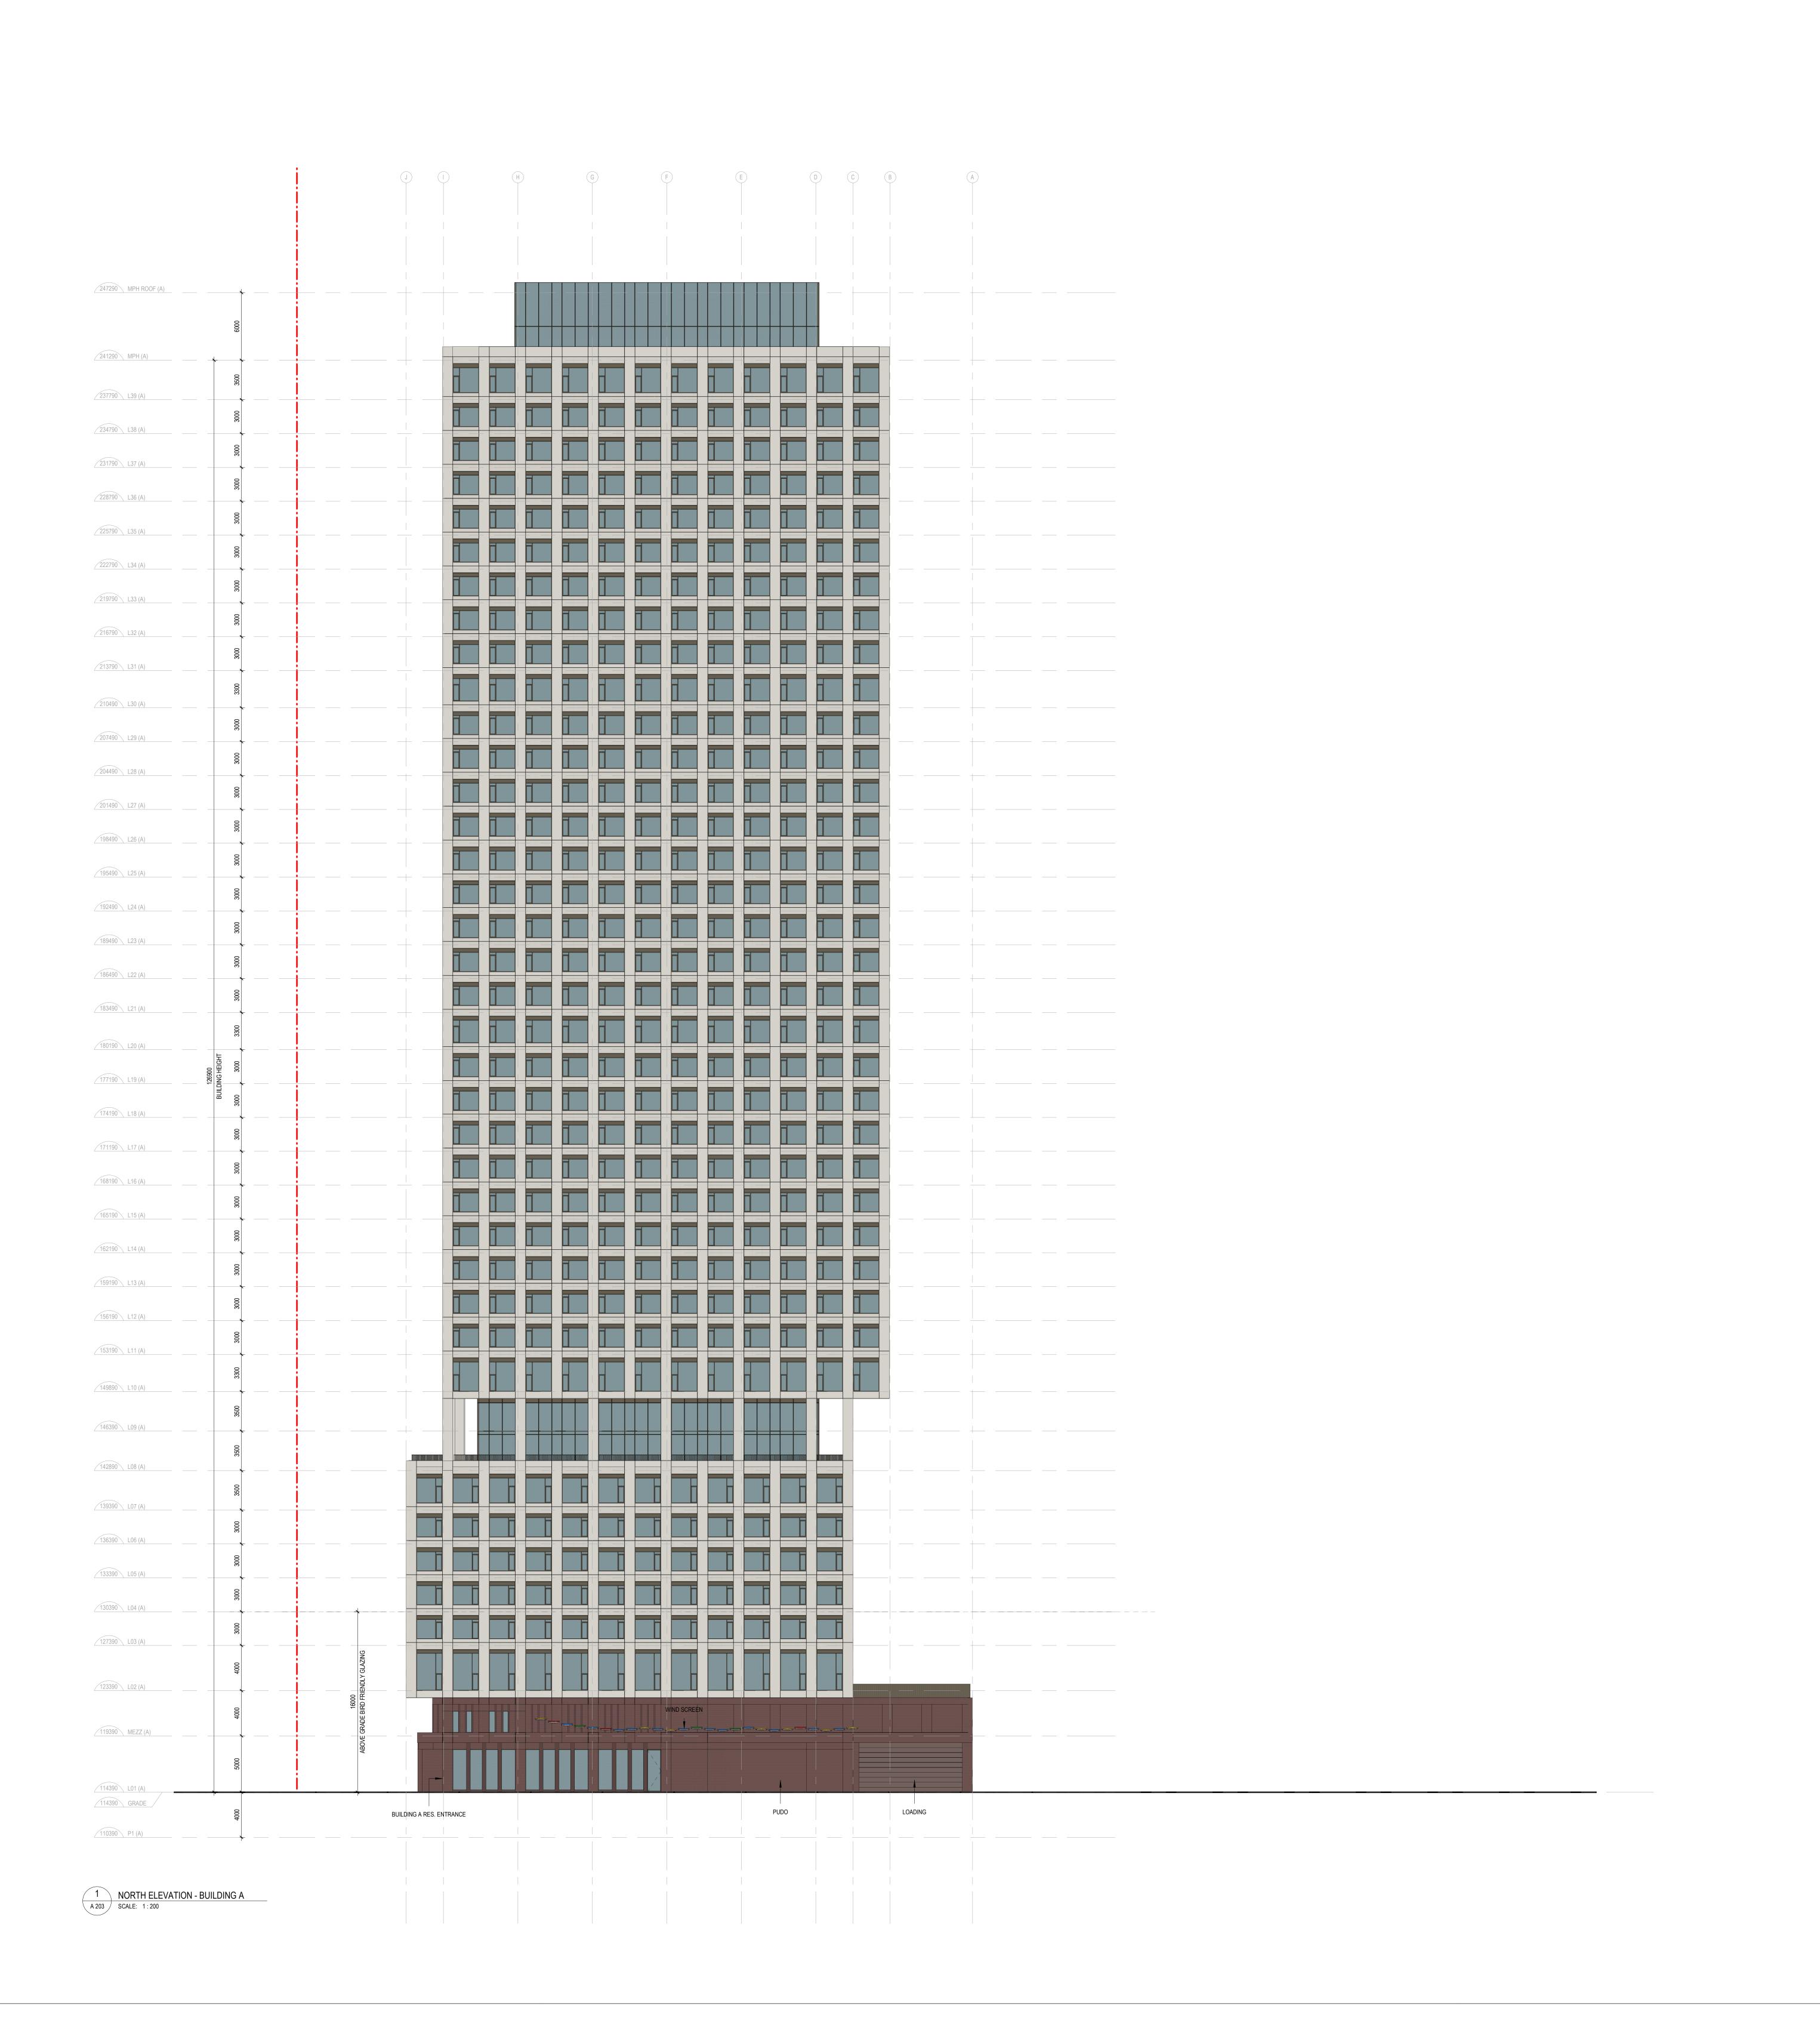
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Building Elevations

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Drawing No.



conditions on site; ascertain any discrepancies between the site and the Contract Documents, and bring these items to the attention of the Architect for clarification.

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Toronto, ON M6R 2J5

MATERIAL LEGEND

PC 01 Propert Congrete Reign

PC-01 Precast Concrete, Beige
Typ.

PC-01a Precast Textured Concrete, Beige
Typ.

PC-02 Precast Concrete, Red Typ.

PC-02a Precast Textured Concrete, Red Typ.

MAS-01 Masonry Type 1
Typ. Red Brick

MAS-02 Masonry Type 2
Typ. Textured Red Brick

MT-01 Metal Type 1
Bronze Aluminium

MT-02 Metal Louver Type 1
Bronze Aluminium

GL-01 Vision and Spandrel Glass

Typ.

GL-02 Bird friendly Vision and Spandrel Glass
Typ.

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20210726 ZAA Submission 1
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o. Date Issue/Revision



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Project No. 2017


Title:

Building Elevations

C

A 203

Scale As indicated

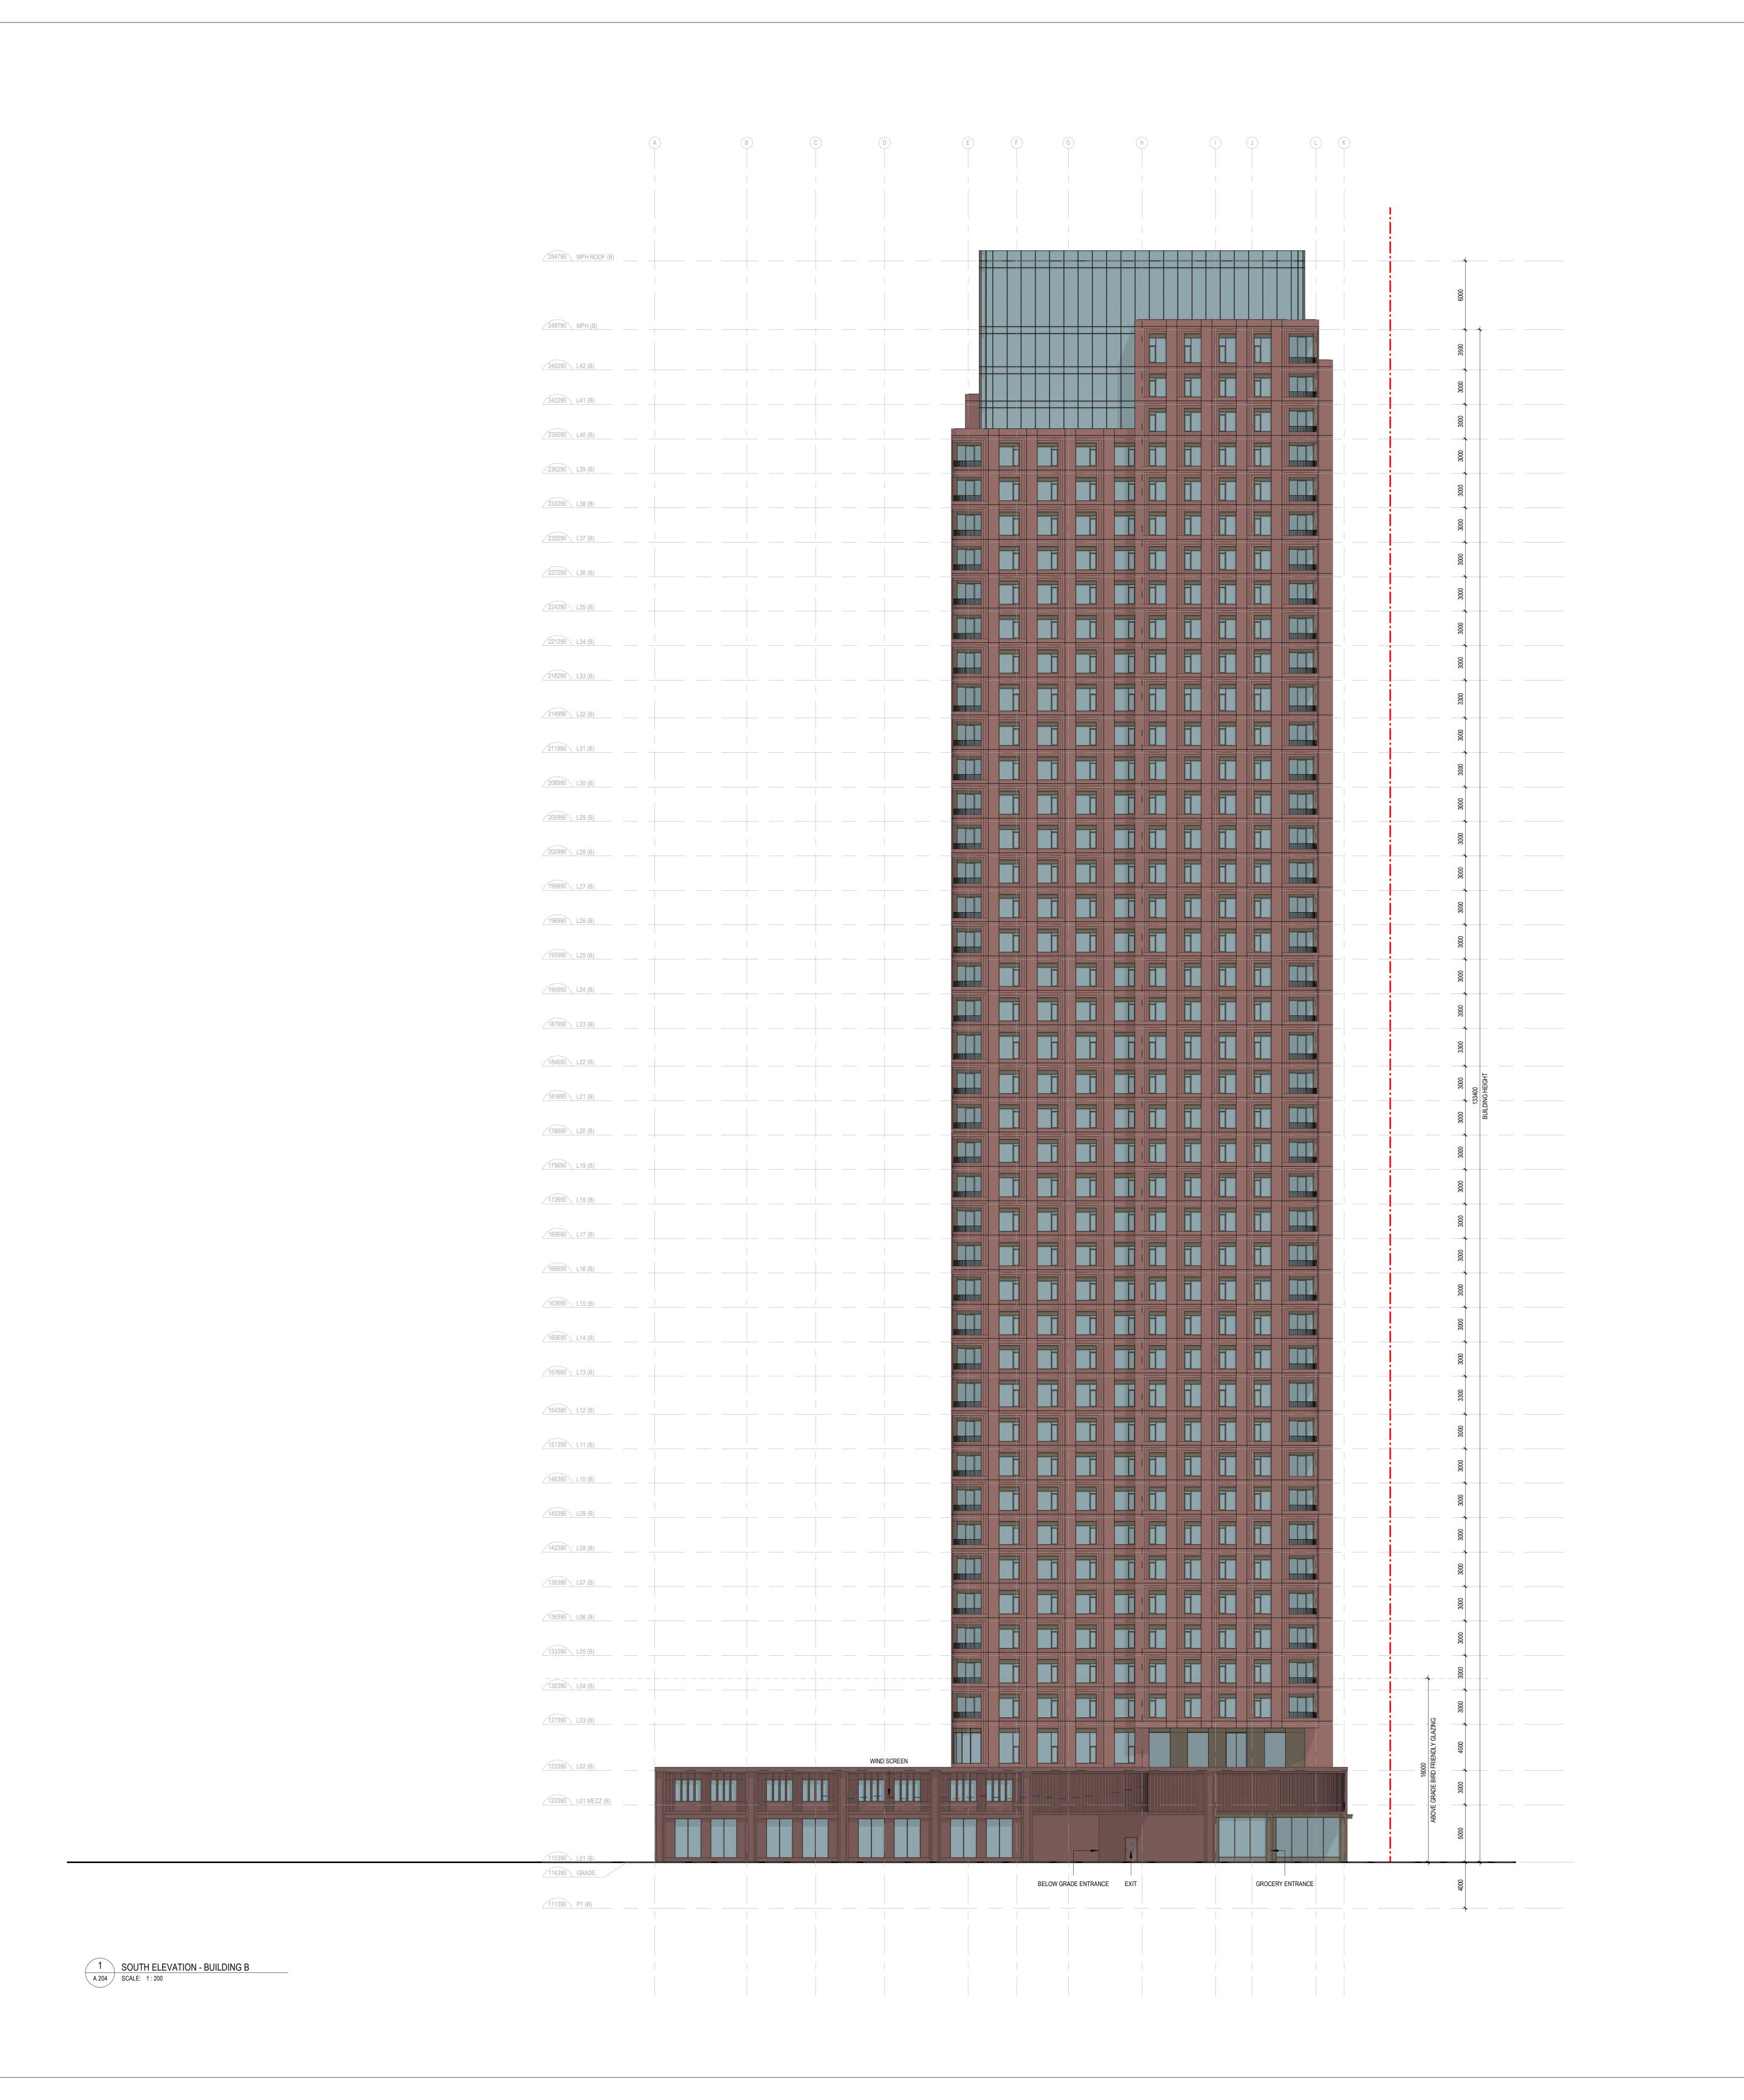

dimensions, datums, and levels with the Contract Documents and with the conditions on site; ascertain any discrepancies between the site and the Contract Documents, and bring these items to the attention of the Architect for clarification.

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ChoicePropertie

MATERIAL LEGEND

PC-01 Precast Concrete, Beige Typ.

PC-01a Precast Textured Concrete, Beige Typ.

PC-02 Precast Concrete, Red Typ.

PC-02 Precast Concrete, Red
Typ.

PC-02a Precast Textured Concrete, Red
Typ.

MAS-01 Masonry Type 1
Typ. Red Brick

MAS-02 Masonry Type 2
Typ. Textured Red Brick

MT-01 Stone Base

MT-01 Metal Type 1

Bronze Aluminium

MT-02 Metal Louver Type 1

Bronze Aluminium

GL-01 Vision and Spandrel Glass
Typ.

GL-02 Bird friendly Vision and Spandrel Glass
Typ.

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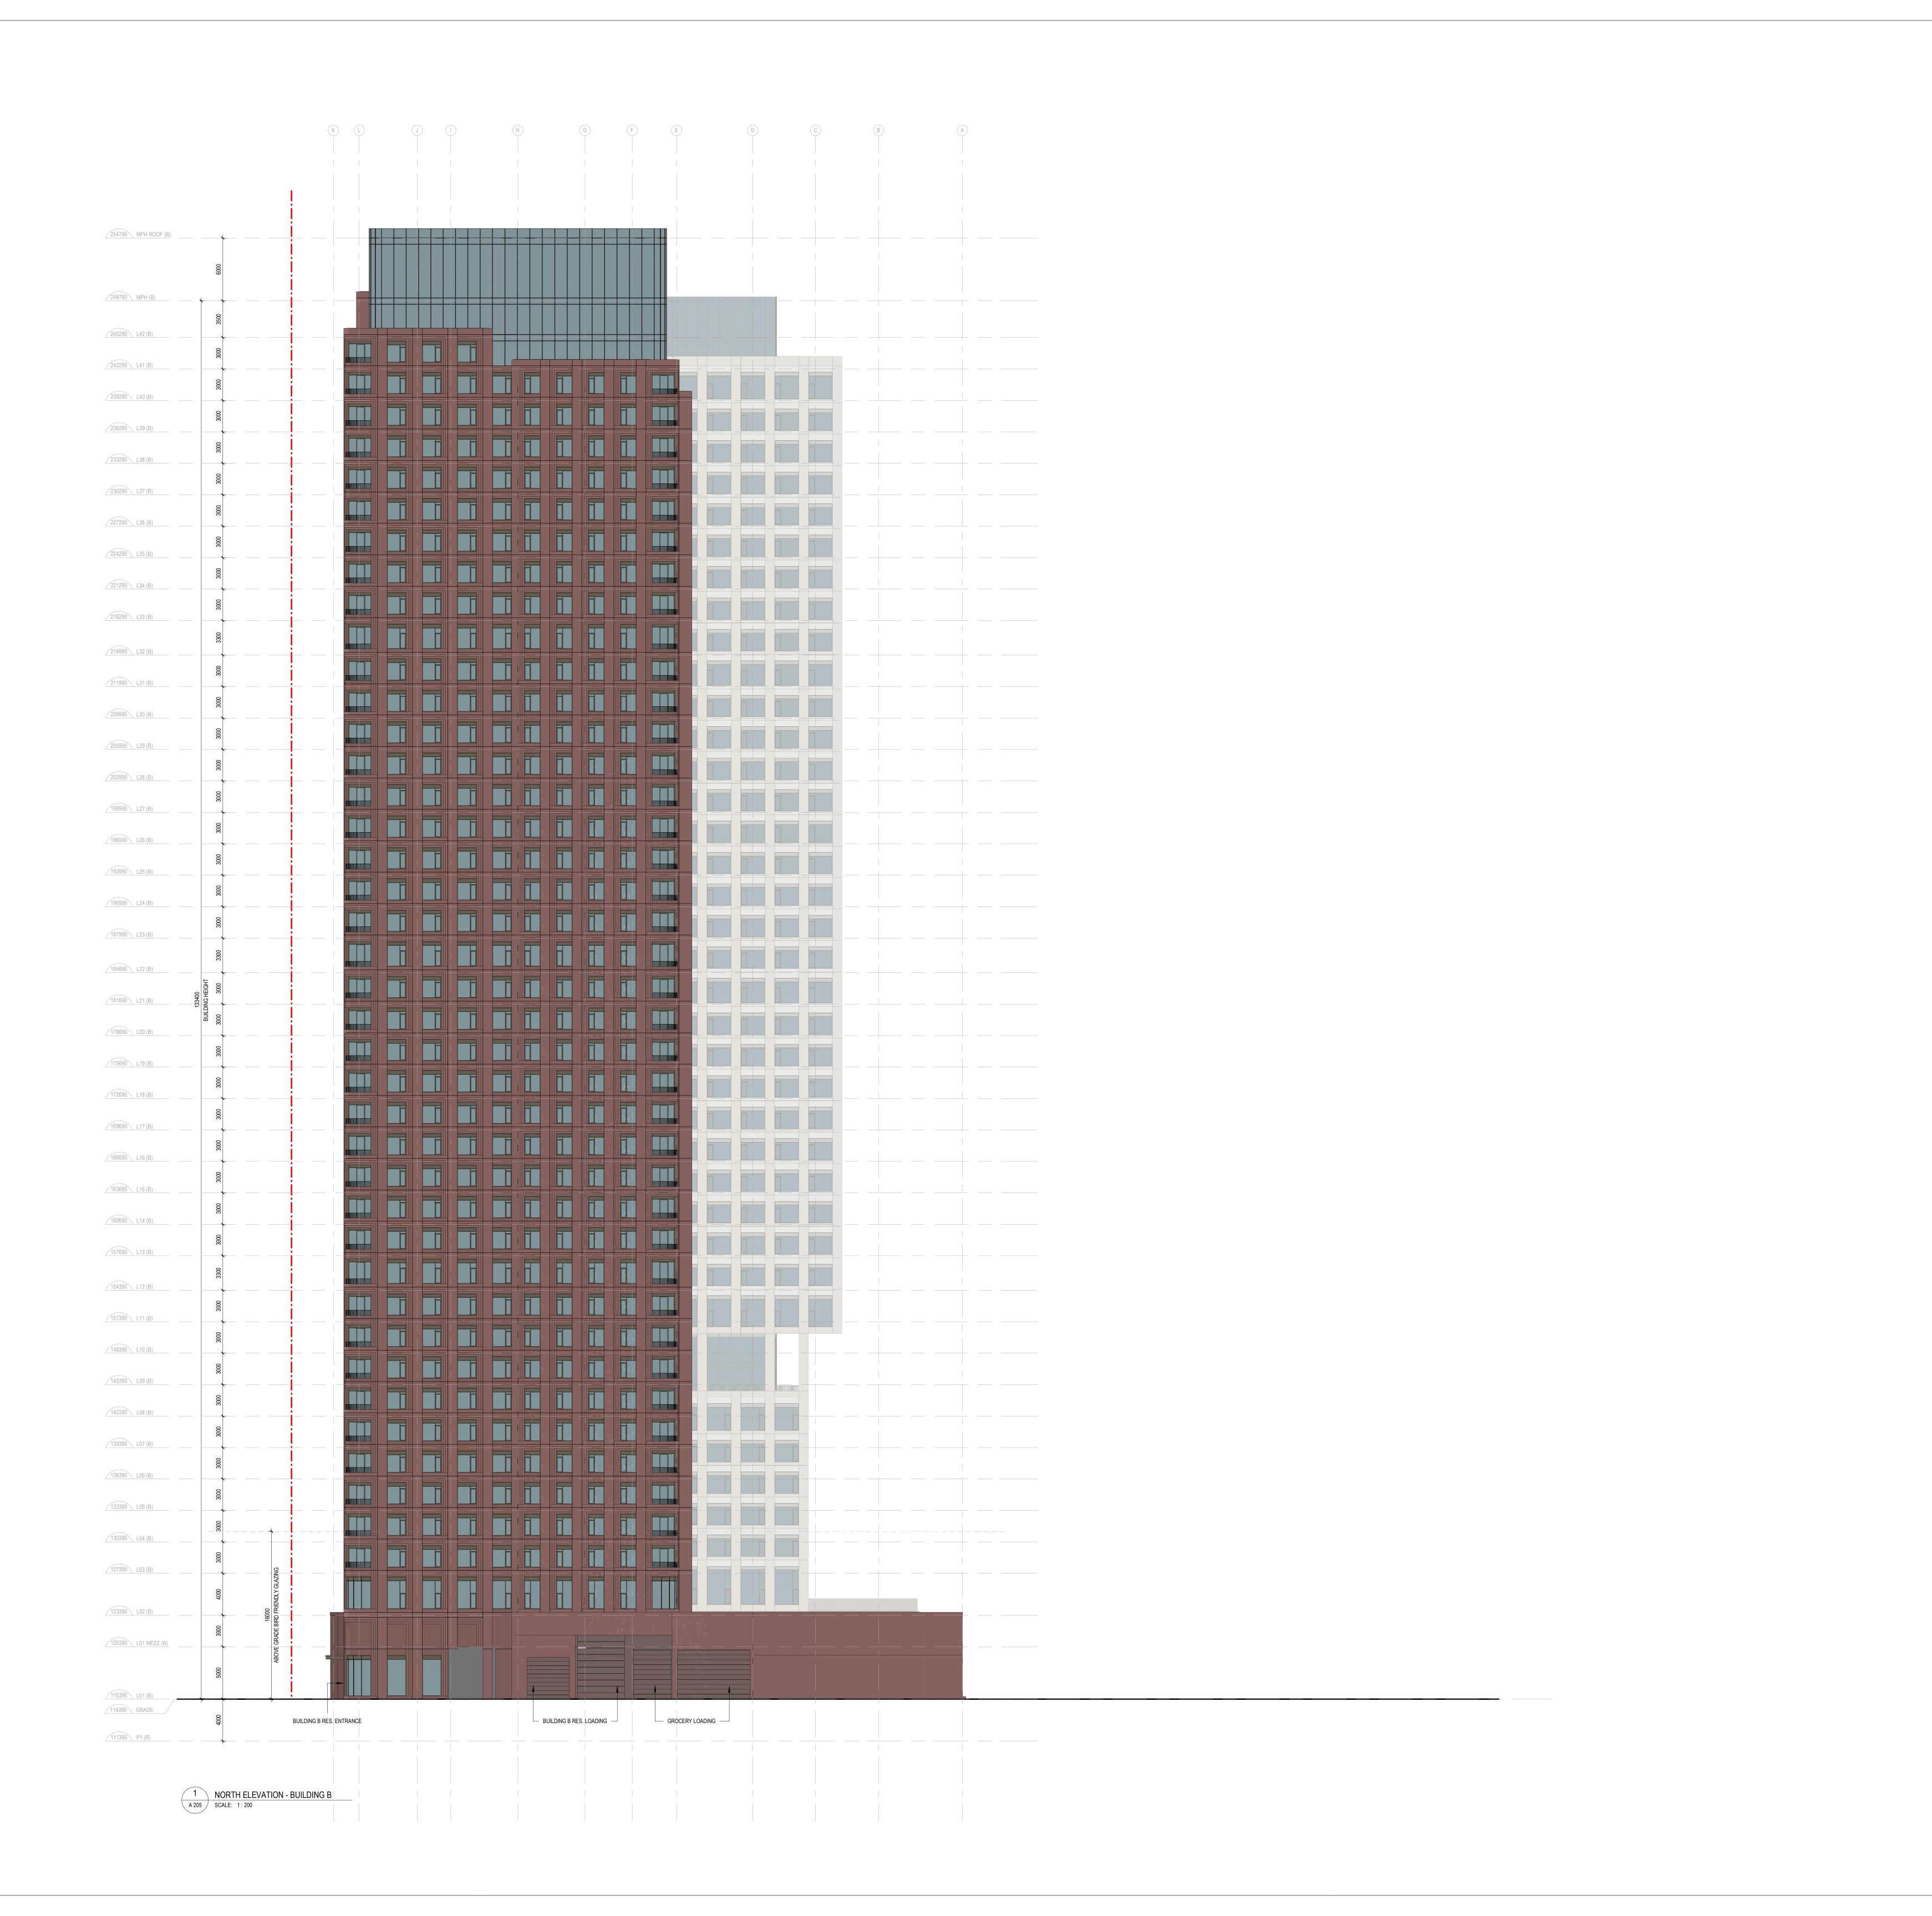
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Building Elevations

Project No. 2017 Scale As indicated

Drawing No.



ChoiceProperties

PC-01 Precast Concrete, Beige Typ.

PC-02 Precast Concrete, Red

MAS-01 Masonry Type 1
Typ. Red Brick

MAS-02 Masonry Type 2
Typ. Textured Red Brick

MT-01 Metal Type 1
Bronze Aluminium

20250926 20210726 20210610

ZAA Submission 1
Pre-App Consult. Meeting

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Building Elevations

A 205

Scale As indicated

682-742 Broadview Ave, Toronto, Ontario

Project No. 2017

MT-02 Metal Louver Type 1
Bronze Aluminium

GL-01 Vision and Spandrel Glass Typ.

GL-02 Bird friendly Vision and Spandrel Glass *Typ*.

PC-01a Precast Textured Concrete, Beige Typ.

PC-02a Precast Textured Concrete, Red *Typ.*

MATERIAL LEGEND

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254790 MPH ROOF (B) MECHANICAL 248790 MPH (B) 247290 MPH ROOF (A) SUITE SUITE SUITE 245290 L42 (B) MECHANICAL SUITE SUITE SUITE 241290 MPH (A) 242290 L41 (B) CORRIDOR SUITE 239290 L40 (B) 237790 L39 (A) CORRIDOR SUITE SUITE SUITE SUITES 236290 L39 (B) 234790 L38 (A) CORRIDOR SUITE SUITE 233290 L38 (B) 231790 L37 (A) CORRIDOR SUITE SUITE 230290 L37 (B) 228790 L36 (A) CORRIDOR SUITE 227290 L36 (B) 225790 L35 (A) SUITE 224290 L35 (B) 222790 L34 (A) CORRIDOR SUITE SUITE SUITE SUITE SUITE 221290 L34 (B) 219790 L33 (A) CORRIDOR SUITE SUITE SUITE 218290 L33 (B) 216790 L32 (A) CORRIDOR SUITE SUITE SUITE 213790 L31 (A) CORRIDOR SUITE SUITE SUITES 211990 L31 (B) 210490 L30 (A) CORRIDOR SUITES 208990 L30 (B) 207490 L29 (A) SUITE SUITE SUITE SUITE 205990 L29 (B) 204490 L28 (A) 201490 L27 (A) SUITE 198490 L26 (A) 196990 L26 (B) 195490 L25 (A) 193990 L25 (B) 192490 L24 (A) 190990 L24 (B) 189490 L23 (A) SUITE 186490 L22 (A) SUITE 184690 L22 (B) 183490 L21 (A) 180190 L20 (A) CORRIDOR 177190 L19 (A) — 17880 — 17900 174190 L18 (A) SUITE 171190 L17 (A) 165190 L15 (A) CORRIDOR SUITE 162190 L14 (A) 159190 L13 (A) SUITE 156190 L12 (A) 154390 L12 (B) 153190 L11 (A) SUITE 151390 L11 (B) 149890 L10 (A) 146390 L09 (A) 145390 L09 (B) 142890 L08 (A) SUITE SUITE SUITE SUITE SUITE 142390 L08 (B) SUITES 139390 L07 (A) SUITE 139390 L07 (B) CORRIDOR 136390 L06 (A) SUITE SUITE SUITE SUITE 136390 L06 (B) CORRIDOR 133390 L05 (A) SUITE SUITE SUITE SUITE 133390 L05 (B) CORRIDOR 130390 L04 (A) SUITE SUITE SUITE SUITE 130390 L04 (B) CORRIDOR 127390 L03 (A) SUITE SUITE 127390 L03 (B) AMENITY **OUTDOOR AMENITY** AMENITY 123390 L02 (A) 123390 L02 (B) BIKE ROOM CORRIDOR CORRIDOR BIKE ROOM 119390 MEZZ (A) 120390 L01 MEZZ (B) LOADING BROADVIEW GARBAGE GROCERY LOADING RES. LOADING LOBBY **GROCERY** BROADVIEW 114390 L01 (A) SERVICE **BIKE ROOM** PARKING 110390 P1 (A) 1 Section 1
A 300 SCALE: 1:200

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conditions on site; ascertain any discrepancies between the site and the Contract Documents, and bring these items to the attention of the Architect for clarification.

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Broadview + Danforth

682-742 Broadview Ave, Toronto, Ontario

Building Section

Project No. 2017

Drawing No.

A 300

Scale 1 : 200

No.	(•	$\overline{(A)}$ $\overline{(2A)}$ $\overline{(3A)}$	(4A)	(2B) (3B) (4B)	5B 6B	(7B) (8B)	9B A	A 3000B (11B)		
State Stat										MPH F
		A 300					MECHANICAL		0009	
	*						WECHANICAL		+	
Total Tota	0009					SUITE	SUITE	SUITE	3200	
10 1		MECHANICAL				SUITE	SUITE		3000	
1.	3500	SUITE	SUITE			SUITE			3000	
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Call	3000	SUITE	SUITE			SUITE			3000	
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Prior to commencement of the Work the Contractor shall verify all drawing dimensions, datums, and levels with the Contract Documents and with the conditions on site; ascertain any discrepancies between the site and the Contract Documents, and bring these items to the attention of the Architect for clarification.

superk"

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 20250926
 ZBA Submission 2

 20210726
 ZAA Submission 1

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 Pre-App Consult. Meeting



Broadview + Danforth

682-742 Broadview Ave, Toronto, Ontario

Building Section

Project No. 2017 Scale 1 : 200